


SHEET NO.	SHEET TITLE
C-1.1	EXISTING CONDITIONS AND DEMOLITION PLAN
C-1.2	EXISTING CONDITIONS AND DEMOLITION PLAN
C-2.1	SITE LAYOUT PLAN
C-2.2	SITE LAYOUT PLAN
C-3.1	TEMPORARY EROSION CONTROL, GRADING AND STORMWATER PLAN
C-3.2	TEMPORARY EROSION CONTROL, GRADING AND STORMWATER PLAN
C-4.1	EROSION CONTROL, GRADING AND STORMWATER PLAN
C-4.2	EROSION CONTROL, GRADING AND STORMWATER PLAN
C-5.1	DRAINAGE AREA PLAN
C-6.1	UTILITY PLAN
C-6.2	UTILITY PLAN
C-7.1	SITE DETAILS
C-7.2	SITE DETAILS
C-7.3	STORM STRUCTURE DETAILS
C-7.4	EROSION CONTROL, GRADING AND STORMWATER DETAILS
C-7.5	EROSION CONTROL, GRADING AND STORMWATER DETAILS
C-7.6	NCG01 GROUND STABILIZING AND MATERIALS HANDLING
C-7.7	NCG01 SELF INSPECTION, RECORD KEEPING AND REPORTING
C-7.8	UTILITY DETAILS
E-1.0	LIGHTING PLAN
L-1.0	LANDSCAPE PLAN
L-2.0	LANDSCAPE DETAILS

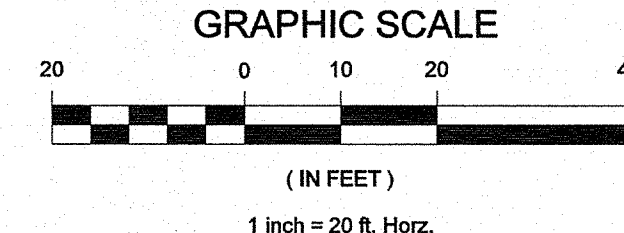


Approved Construction Plan

Name: Nicole D Smith Date: 1/30/20

Traffic: W. Smith Date: 1-20-20

Fire: C. White Date: 1/30/20

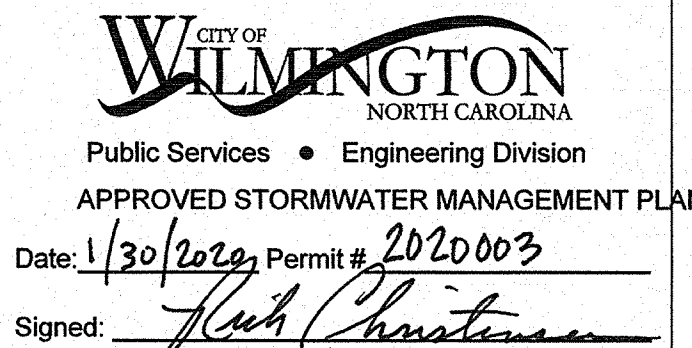

For each open utility cut of City streets, a \$325 permit shall be required from the City prior to occupancy and/or project acceptance

LAND SURVEYOR NOTES:

- HORIZONTAL AND VERTICAL CONTROL WAS ESTABLISHED FROM NC VRS.
- COORDINATES SHOWN ARE GRID COORDINATES.
- ALL BEARINGS ARE GRID BEARINGS UNLESS OTHERWISE NOTED.
- ALL DISTANCES ARE HORIZONTAL GROUND DISTANCES UNLESS OTHERWISE NOTED.
- AREAS ARE COMPUTED BY COORDINATE METHOD.
- THIS MAP IS SUBJECT TO ANY FACTS THAT MAY BE DISCLOSED BY A FULL AND ACCURATE TITLE SEARCH.
- SUBJECT AREA LOCATED WITHIN FLOOD HAZARD ZONE "X" AS SCALED FROM FIRM MAP # 3720313500K, EFFECTIVE DATE, AUGUST 28, 2018.
- EXISTING UTILITIES AND STRUCTURES SHOWN, BOTH UNDERGROUND AND ABOVE GROUND, ARE BASED ON SURFACE OBSERVATIONS, UTILITY PAINT MARKINGS PROVIDED BY 811, AND THE BEST AVAILABLE RECORD DRAWINGS. ALL UTILITY LOCATIONS ARE TO BE ASSUMED, AT BEST, AND SHOULD BE FIELD VERIFIED.
- SEE PLAT FOR ARBOR COMMONS PREPARED BY ATLANTIC COAST SURVEY, PLLC, DATED 9/19/17 AND RECORDED IN P.B. 63, PG. 336.

ENGINEER NOTES:

- NO WETLANDS EXIST ON SITE PER USAGE JURISDICTION DETERMINATION ISSUED 4-9-2019 BY ACTION ID SAW-2012-05564.
- THERE ARE NO SURFACE WATERS, WETLANDS, REGULATORY FLOOD ZONES, PROTECTED VEGETATED SETBACKS, OR PROTECTED RIPARIAN BUFFERS ON THE SITE.

- MARKERS:
- EXISTING RIGHT OF WAY MONUMENT
 - EXISTING CONCRETE MONUMENT
 - EXISTING IRON PIPE
 - IRON PIPE SET
 - EXISTING IRON ROD
 - REBAR SET
 - PK NAIL FOUND
 - PK NAIL SET
 - EXISTING GEODETIC MONUMENT
 - TRAVERSE NAIL
 - CALCULATED PROPERTY CORNER
 - EXISTING BENCHMARK

- RWM
 - ECM
 - IP
 - IPS
 - EIR
 - IRS
 - PKS
 - EGM
 - TN
 - BM
- PROPOSED BENCHMARK
- CONTROL CORNER
- NOW OR FORMERLY
- WETLAND FLAG
- LINES:
- RIGHT OF WAY
- PROPERTY LINE, SURVEYED
- PROPERTY LINE, NOT SURVEYED
- PROPOSED PROPERTY LINE
- EXISTING EASEMENT
- PROPOSED EASEMENT
- EXISTING EDGE OF WATER
- PROPOSED EDGE OF WATER

- 100 YEAR FLOOD PLAIN
- AEC LINE
- CAMA LINE
- BUFFER LINE
- EXISTING WETLAND LINE
- EXISTING HIGH WATER LINE
- GRADING:
- EXISTING MINOR CONTOUR
- EXISTING MAJOR CONTOUR
- EXISTING SPOT ELEVATION
- TREE PROTECTION
- PROPOSED DEMOLITION

Curve #	Length	Radius	Delta	Chord	Chord Direction
C10	75.96'	522.50'	8.33	75.89'	S87°08'40"E
C11	182.18'	522.50'	19.98	181.26'	N78°42'08"E
C12	39.97'	200.00'	11.45	39.90'	S15°33'43"E
C13	209.75'	477.50'	25.17	208.07'	N79°45'58"E
C14	38.79'	200.00'	11.11	38.73'	S82°05'35"E
C15	38.79'	200.00'	11.11	38.73'	S82°05'35"E
C16	38.84'	25.00'	89.01	35.05'	S43°08'43"E
C17	132.76'	279.73'	27.19	131.52'	S8°36'13"W
C18	117.43'	616.45'	10.91	117.25'	N84°21'46"E

SEPI

1 GLENWOOD AVE, SUITE 600
RALEIGH, NC 27603
PHONE 919.789.9977

11020 DAVID TAYLOR DR., SUITE 115
CHARLOTTE, NC 28226
PHONE 704.714.4880

5030 NEW CENTRE DR., SUITE B
WILMINGTON, NC 28403
PHONE 910.523.5715

sepic.com


811

Know what's below.
Call before you dig.
3 WORKING DAYS
BEFORE YOU DIG

FOR THE LOCATION OF
UNDERGROUND FACILITIES

THE LOCATION OF EXISTING UNDERGROUND UTILITIES ARE SHOWN IN APPROXIMATE ONLY AND ARE NOT TO BE DEPENDENTLY VERIFIED BY THE OWNER OR ITS REPRESENTATIVE. THE CONTRACTOR SHALL DETERMINE THE EXACT LOCATION OF ALL EXISTING UTILITIES BEFORE COMMENCING WORK, AND AGREES TO BE FULLY RESPONSIBLE FOR ANY AND ALL DAMAGES WHICH MAY BE OCCURRED BY THE CONTRACTOR'S FAILURE TO EXACTLY LOCATE AND PRESERVE ANY AND ALL UNDERGROUND UTILITIES.

NOTICE:
CONSTRUCTION SITE SAFETY IS THE SOLE RESPONSIBILITY OF THE CONTRACTOR. NEITHER THE OWNER NOR THE ENGINEER SHALL BE EXPECTED TO ASSUME ANY RESPONSIBILITY FOR SAFETY OF THE WORK OF PERSONS ENGAGED IN THE WORK OF ANY HEAVY STRUCTURES, OR OF ANY OTHER PERSONS.

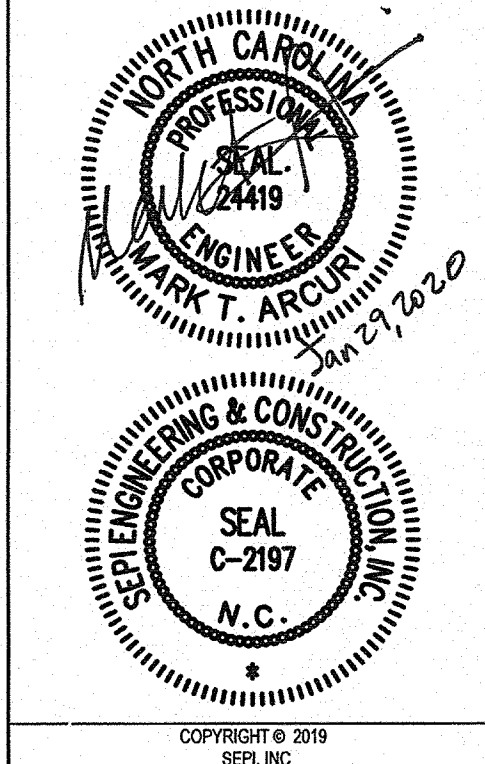

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OWNER/DEVELOPER/APPLICANT:
STATE EMPLOYEES' CREDIT UNION

ADDRESS:
119 N. SALISBURY STREET
RALEIGH, NORTH CAROLINA 27603
PHONE: 919-839-5300

PROJECT:
STATE EMPLOYEES' CREDIT UNION - WILMINGTON
S 17th STREET BRANCH

PROJECT MANAGER:
MTA

FIELD SURVEY DATE:
02/16/19

CHECKED BY:
DM

DRAWING DATE:
12/03/2019

DRAWN BY:
KD

JOB #:
SE18.191.00



SHEET
C-1.1




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MATCHLINE - SHEET C-1.1

N/F
LG JOHN BARRY DRIVE LLC
DB 6012 PG 61
ZONE: CB

LOT 1
3.964 AC.
TAX PARCEL #R06600-001-005-012

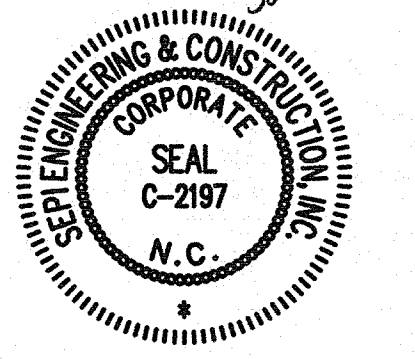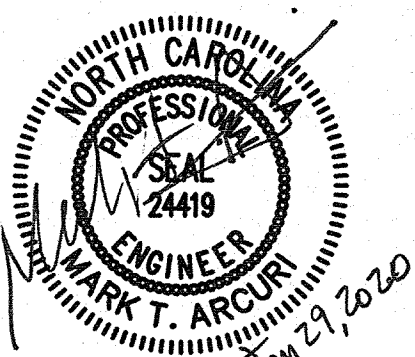
N/F
LG JOHN BARRY DRIVE LLC
DB 6012 PG 61
ZONE: CB
UNDEVELOPED

LOT 4

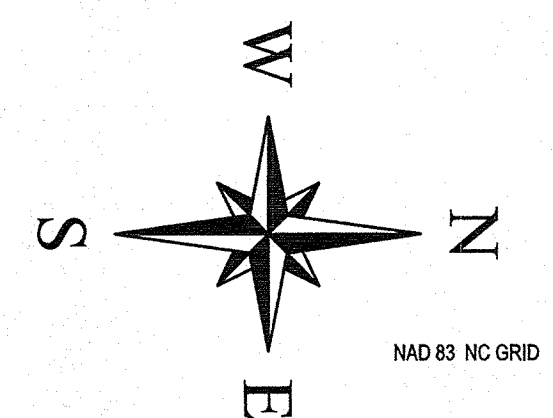
ZONING CONDITIONS
SECTION 2: THE FOLLOWING RULES, REGULATIONS AND CONDITIONS SHALL APPLY TO THE PROPERTY DESCRIBED IN THE ORDINANCE:

1. THE USE AND DEVELOPMENT OF THE SUBJECT PROPERTY SHALL COMPLY WITH ALL REGULATIONS AND REQUIREMENTS OF THE LAND DEVELOPMENT CODE, THE CITY OF WILMINGTON TECHNICAL STANDARDS AND SPECIFICATIONS MANUAL AND ANY OTHER APPLICABLE FEDERAL, STATE OR LOCAL LAW, ORDINANCE OR REGULATION, AS WELL AS ANY CONDITION STATED BELOW. IN THE EVENT OF A CONFLICT, THE MORE STRINGENT REQUIREMENT OR HIGHER STANDARD SHALL APPLY.
2. APPROVAL OF THIS ZONING REQUEST DOES NOT CONSTITUTE TECHNICAL APPROVAL OF THE SITE PLAN. FINAL APPROVAL BY THE TECHNICAL REVIEW COMMITTEE AND THE ISSUANCE OF ALL REQUIRED PERMITS MUST OCCUR PRIOR TO RELEASE OF THE PROJECT FOR CONSTRUCTION.
3. IF, FOR ANY REASON, ANY CONDITION FOR APPROVAL IS FOUND TO BE ILLEGAL OR INVALID OR IF THE APPLICANT SHOULD FAIL TO ACCEPT ANY CONDITION FOLLOWING APPROVAL, THE APPROVAL OF THE SITE PLAN FOR THE DISTRICT SHALL BE NULL AND VOID AND OF NO EFFECT AND PROCEEDINGS SHALL BE INSTITUTED TO REZONE THE PROPERTY TO ITS PREVIOUS ZONING CLASSIFICATION.
4. THE USE AND DEVELOPMENT OF THE SUBJECT PROPERTY SHALL BE IN ACCORDANCE WITH THE PLAN AS SUBMITTED APRIL 25, 2016.
5. ALL EXISTING PROTECTED TREES NOT IMPACTED BY ESSENTIAL SITE IMPROVEMENTS SHALL BE PRESERVED OR MITIGATED.
6. EXTERIOR SITE LIGHTING SHALL BE INSTALLED SO AS NOT TO SHINE DIRECTLY ONTO ADJACENT PARCELS AND SHALL BE LIMITED TO FULL CUTOFF TYPE FIXTURES.
7. A CONCEPTUAL SITE LIGHTING PLAN SHALL BE SUBMITTED PRIOR TO CONSTRUCTION RELEASE.
8. ANY FREESTANDING SIGN(S) ON THE SITE SHALL BE MONUMENT STYLE WITH LANDSCAPING AROUND THE BASE OF THE SIGN; NO POLE SIGNS SHALL BE PERMITTED.
9. TREE PROTECTION FENCING SHALL BE INSTALLED AROUND ALL PROTECTED TREES WITH SIGNAGE OF NO MATERIAL STORAGE IN ENGLISH AND SPANISH.
10. ALL REQUIREMENTS OF THE TRAFFIC IMPACT ANALYSIS (TIA) SHALL BE FOLLOWED, AND REQUIRED IMPROVEMENTS SHALL BE CONSTRUCTED BY THE APPLICANT PRIOR TO ISSUANCE OF ANY CERTIFICATES OF OCCUPANCY.
11. ALL CITY, STATE AND FEDERAL REGULATIONS SHALL BE FOLLOWED.
12. THE PROPOSED BUILDING ELEVATIONS ALONG SOUTH 17TH STREET SHALL BE CONSTRUCTED SO AS TO AVOID THE APPEARANCE OF BLANK WALLS.
13. THE APPLICANT SHALL PROVIDE TRAFFIC CALMING AT THE PROPOSED "T" INTERSECTION OF THE THROUGH ACCESS DRIVEWAY WITH THE PROPOSED PUBLIC STREET.


Approved Construction Plan	
Name	Date
Nicole D. Smith	1/30/20
Traffic	1-30-20
Fire	1/30/20

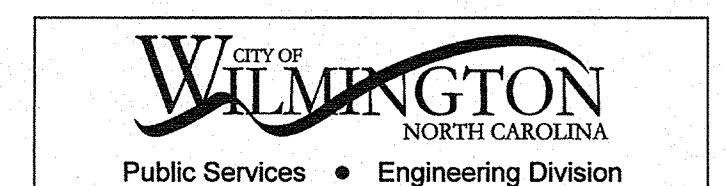

APPROVED STORMWATER MANAGEMENT PLAN
Date: 1/30/2020 permit # 2020003
Signed: Rich Christen

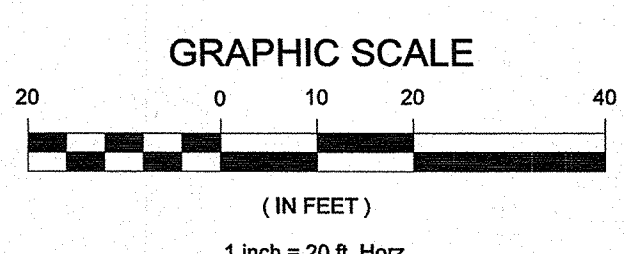

For each open utility cut of City streets, a \$325 permit shall be required from the City prior to occupancy and/or project acceptance



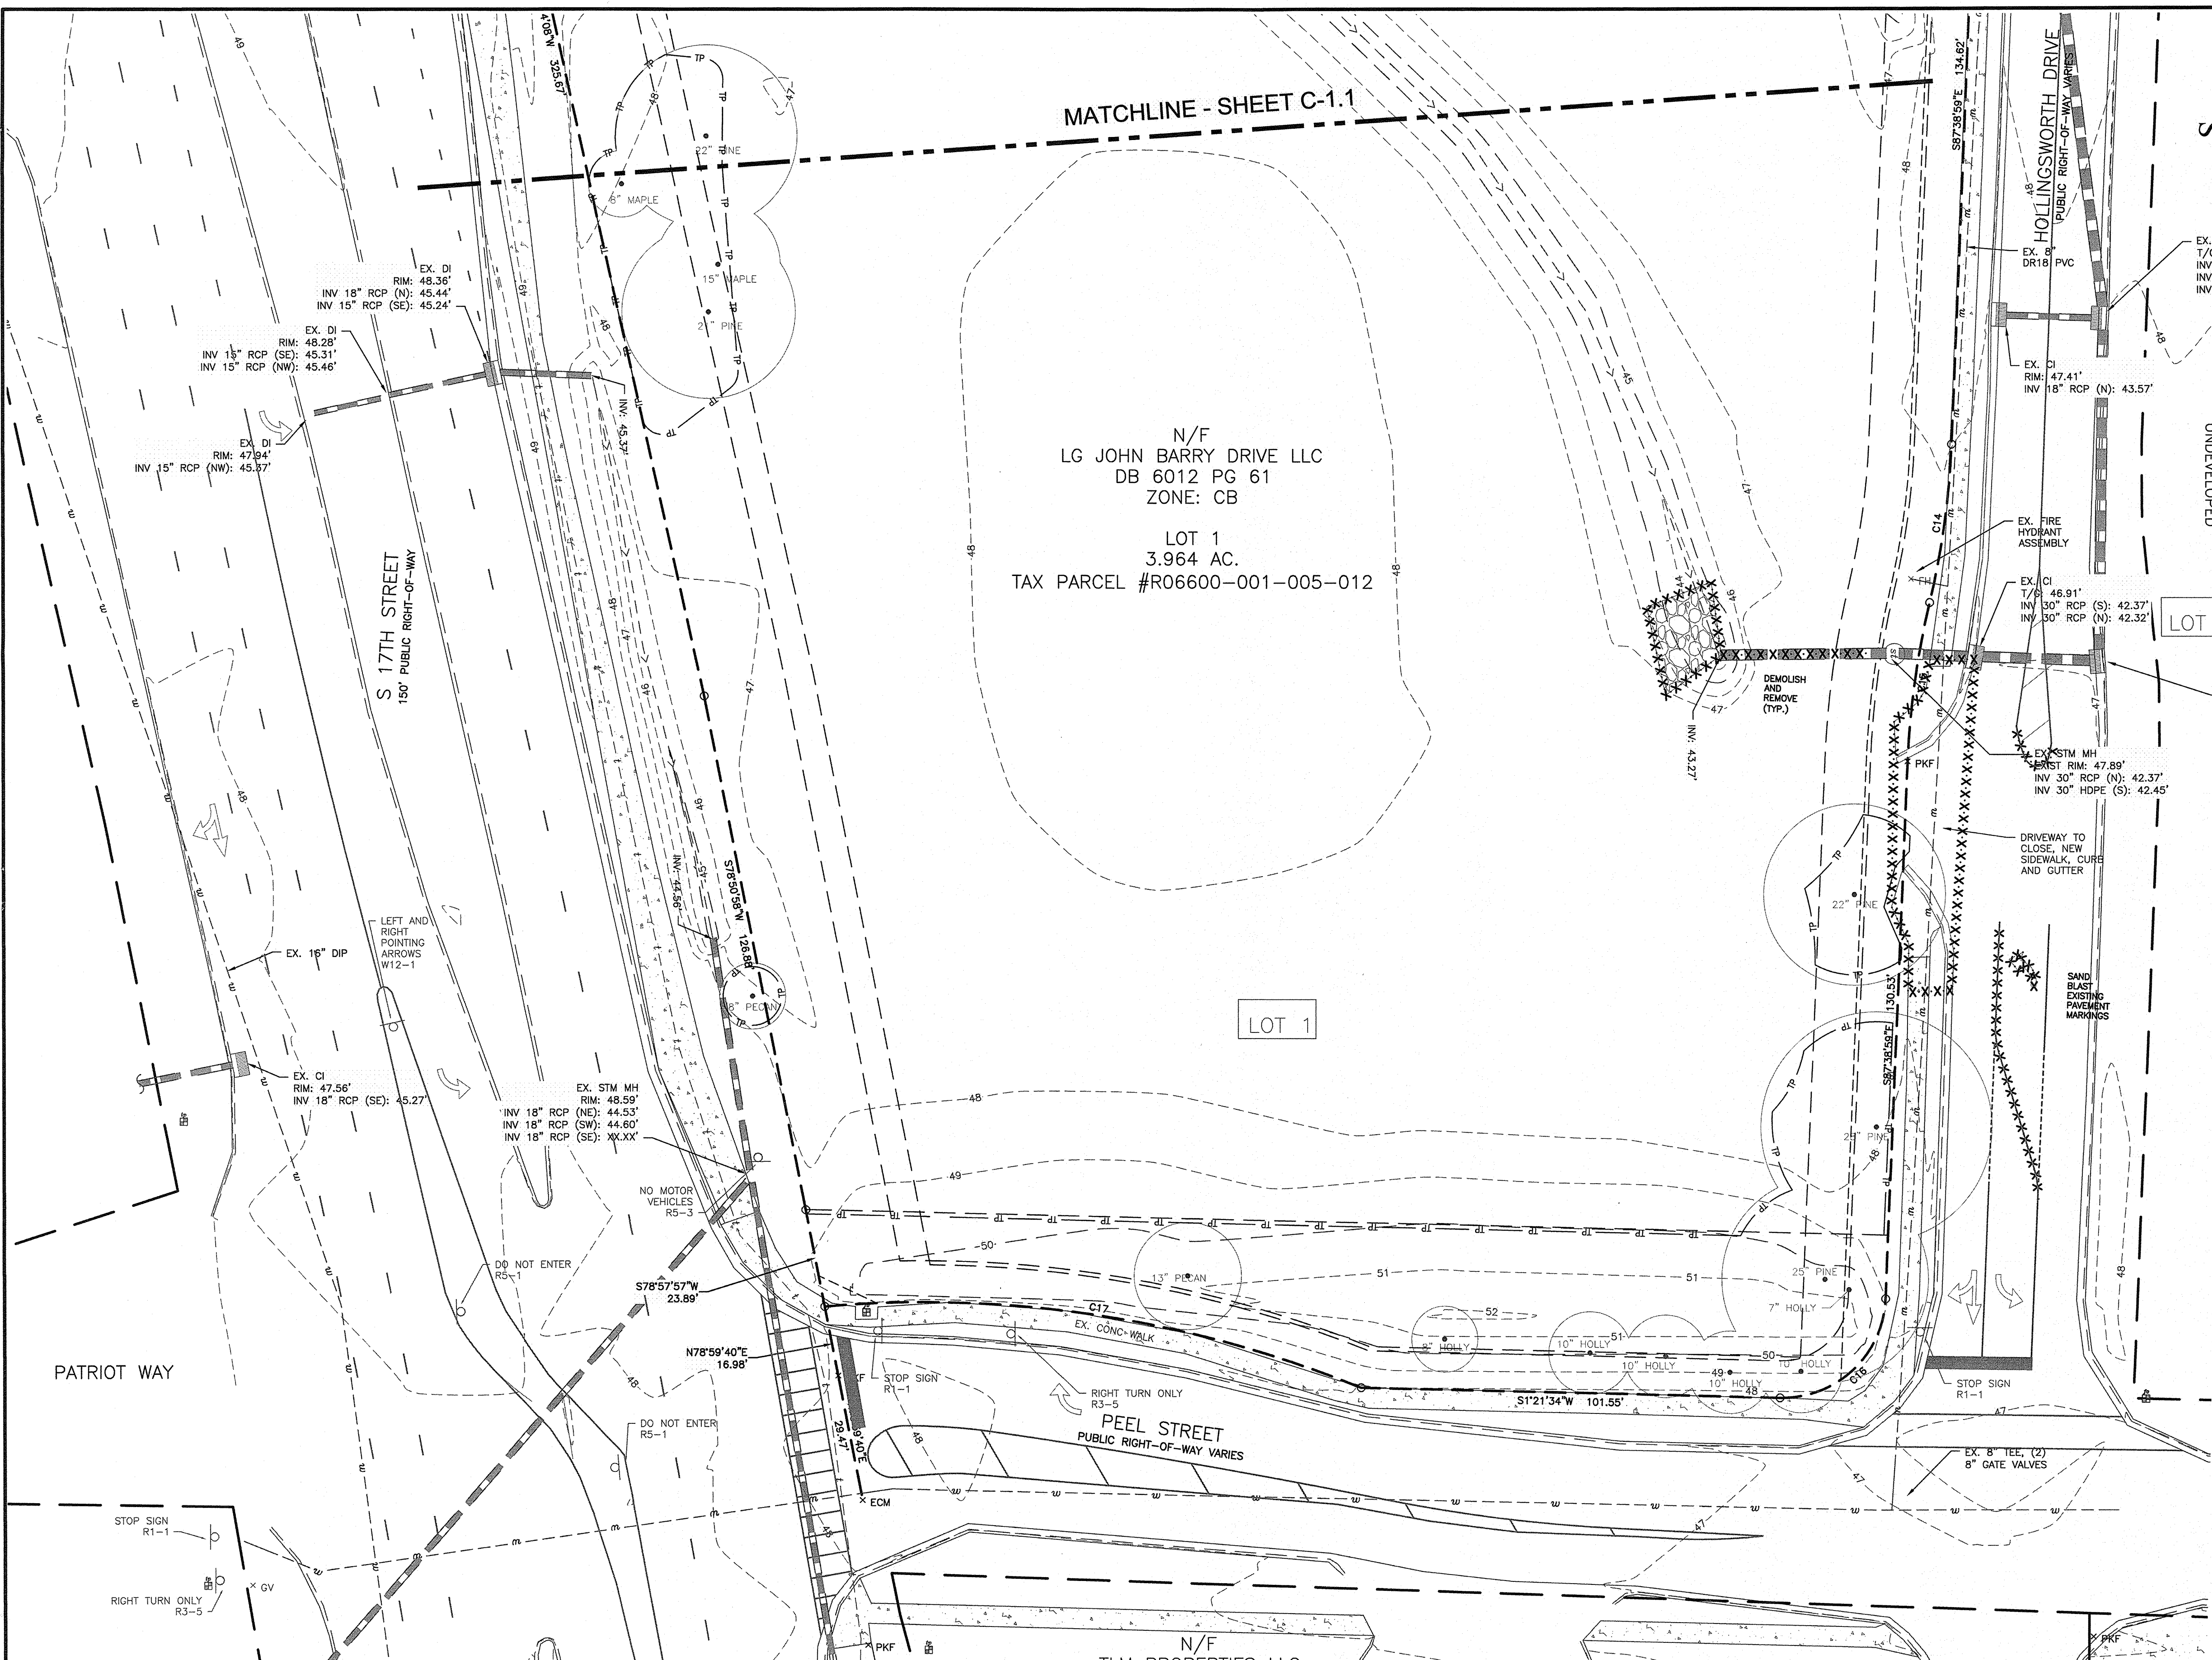


GEOTECHNICAL NOTES

1. THE SURGRADE PREPARATION SHOULD CONSIST OF STRIPPING VEGETATION, ROOTMATS, TOPSOIL, EXISTING FILL, AND ANY OTHER SOFT OR UNSUITABLE MATERIALS FROM THE 10-FOOT EXPANDED BUILDING AND FOOTING EXPANDED PAVEMENT LINES AND TO 2 FEET BEYOND THE TOE OF STRUCTURAL FILLS. THE HAND AUGER BORINGS PERFORMED AT THE SITE ENCOUNTERED ROOTS TO DEPTHS OF 1.75 TO 2.0 FEET. DEEPER TOPSOIL OR ORGANIC LOAM SOILS ARE TYPICALLY PRESENT IN WET, LOW-LYING, AND POORLY DRAINED AREAS. THE GEOTECHNICAL CONSULTANT SHOULD BE CALLED TO VERIFY THAT TOPSOIL, ROOTS, AND UNSUITABLE SURFICIAL MATERIALS HAVE BEEN REMOVED PRIOR TO THE PLACEMENT OF STRUCTURAL FILL OR CONSTRUCTION OF STRUCTURES.
2. IN THE LOCATION OF THE EXISTING DITCHES ON SITE, PRIOR TO PLACEMENT OF FILL OR CONSTRUCTION, APPROXIMATELY 2 FEET OF SURFACE MATERIAL WILL NEED TO BE MICKED OUT. ACTUAL UNDERCUT DEPENDS ON THE AMOUNT OF ORGANIC SBT ENCOUNTERED. DUE TO THE ROOTS ENCOUNTERED IN THE HAND AUGER BORINGS, ISOLATED UNDERCUTTING TO DEPTHS OF APPROXIMATELY 2 FEET MAY BE NEEDED PRIOR TO PLACEMENT OF FILL.

OWNER/DEVELOPER/APPLICANT		STATE EMPLOYEES' CREDIT UNION	
ADDRESS: 119 N. SALISBURY STREET RALEIGH, NORTH CAROLINA 27603 PHONE: 919-839-5300		ADDRESS: 4355 S. 17TH STREET WILMINGTON NC 28412	

PROJECT		EXISTING CONDITIONS AND DEMOLITION PLAN	
STATE EMPLOYEES' CREDIT UNION - WILMINGTON S 17th STREET BRANCH		PROJECT MANAGER MTA	FIELD SURVEY DATE: 02/15/19
CHECKED BY: DM	DRAWING DATE: 12/03/2019	DRAWN BY: KD	JOB #: SE1819100
SHEET C-12			

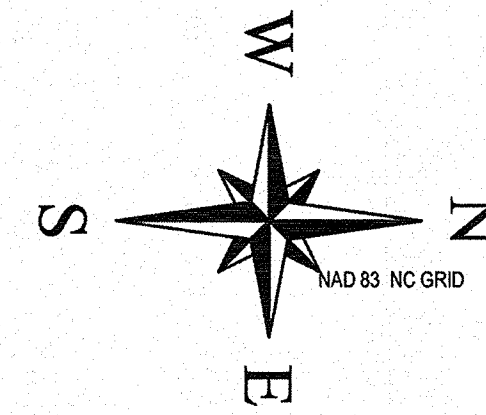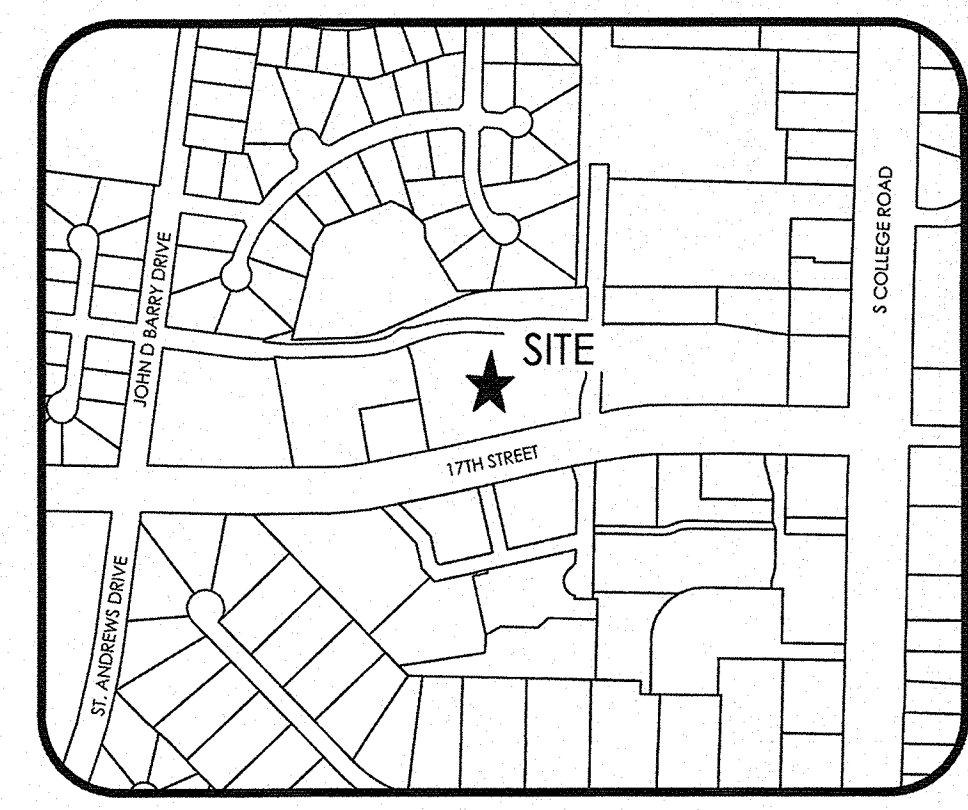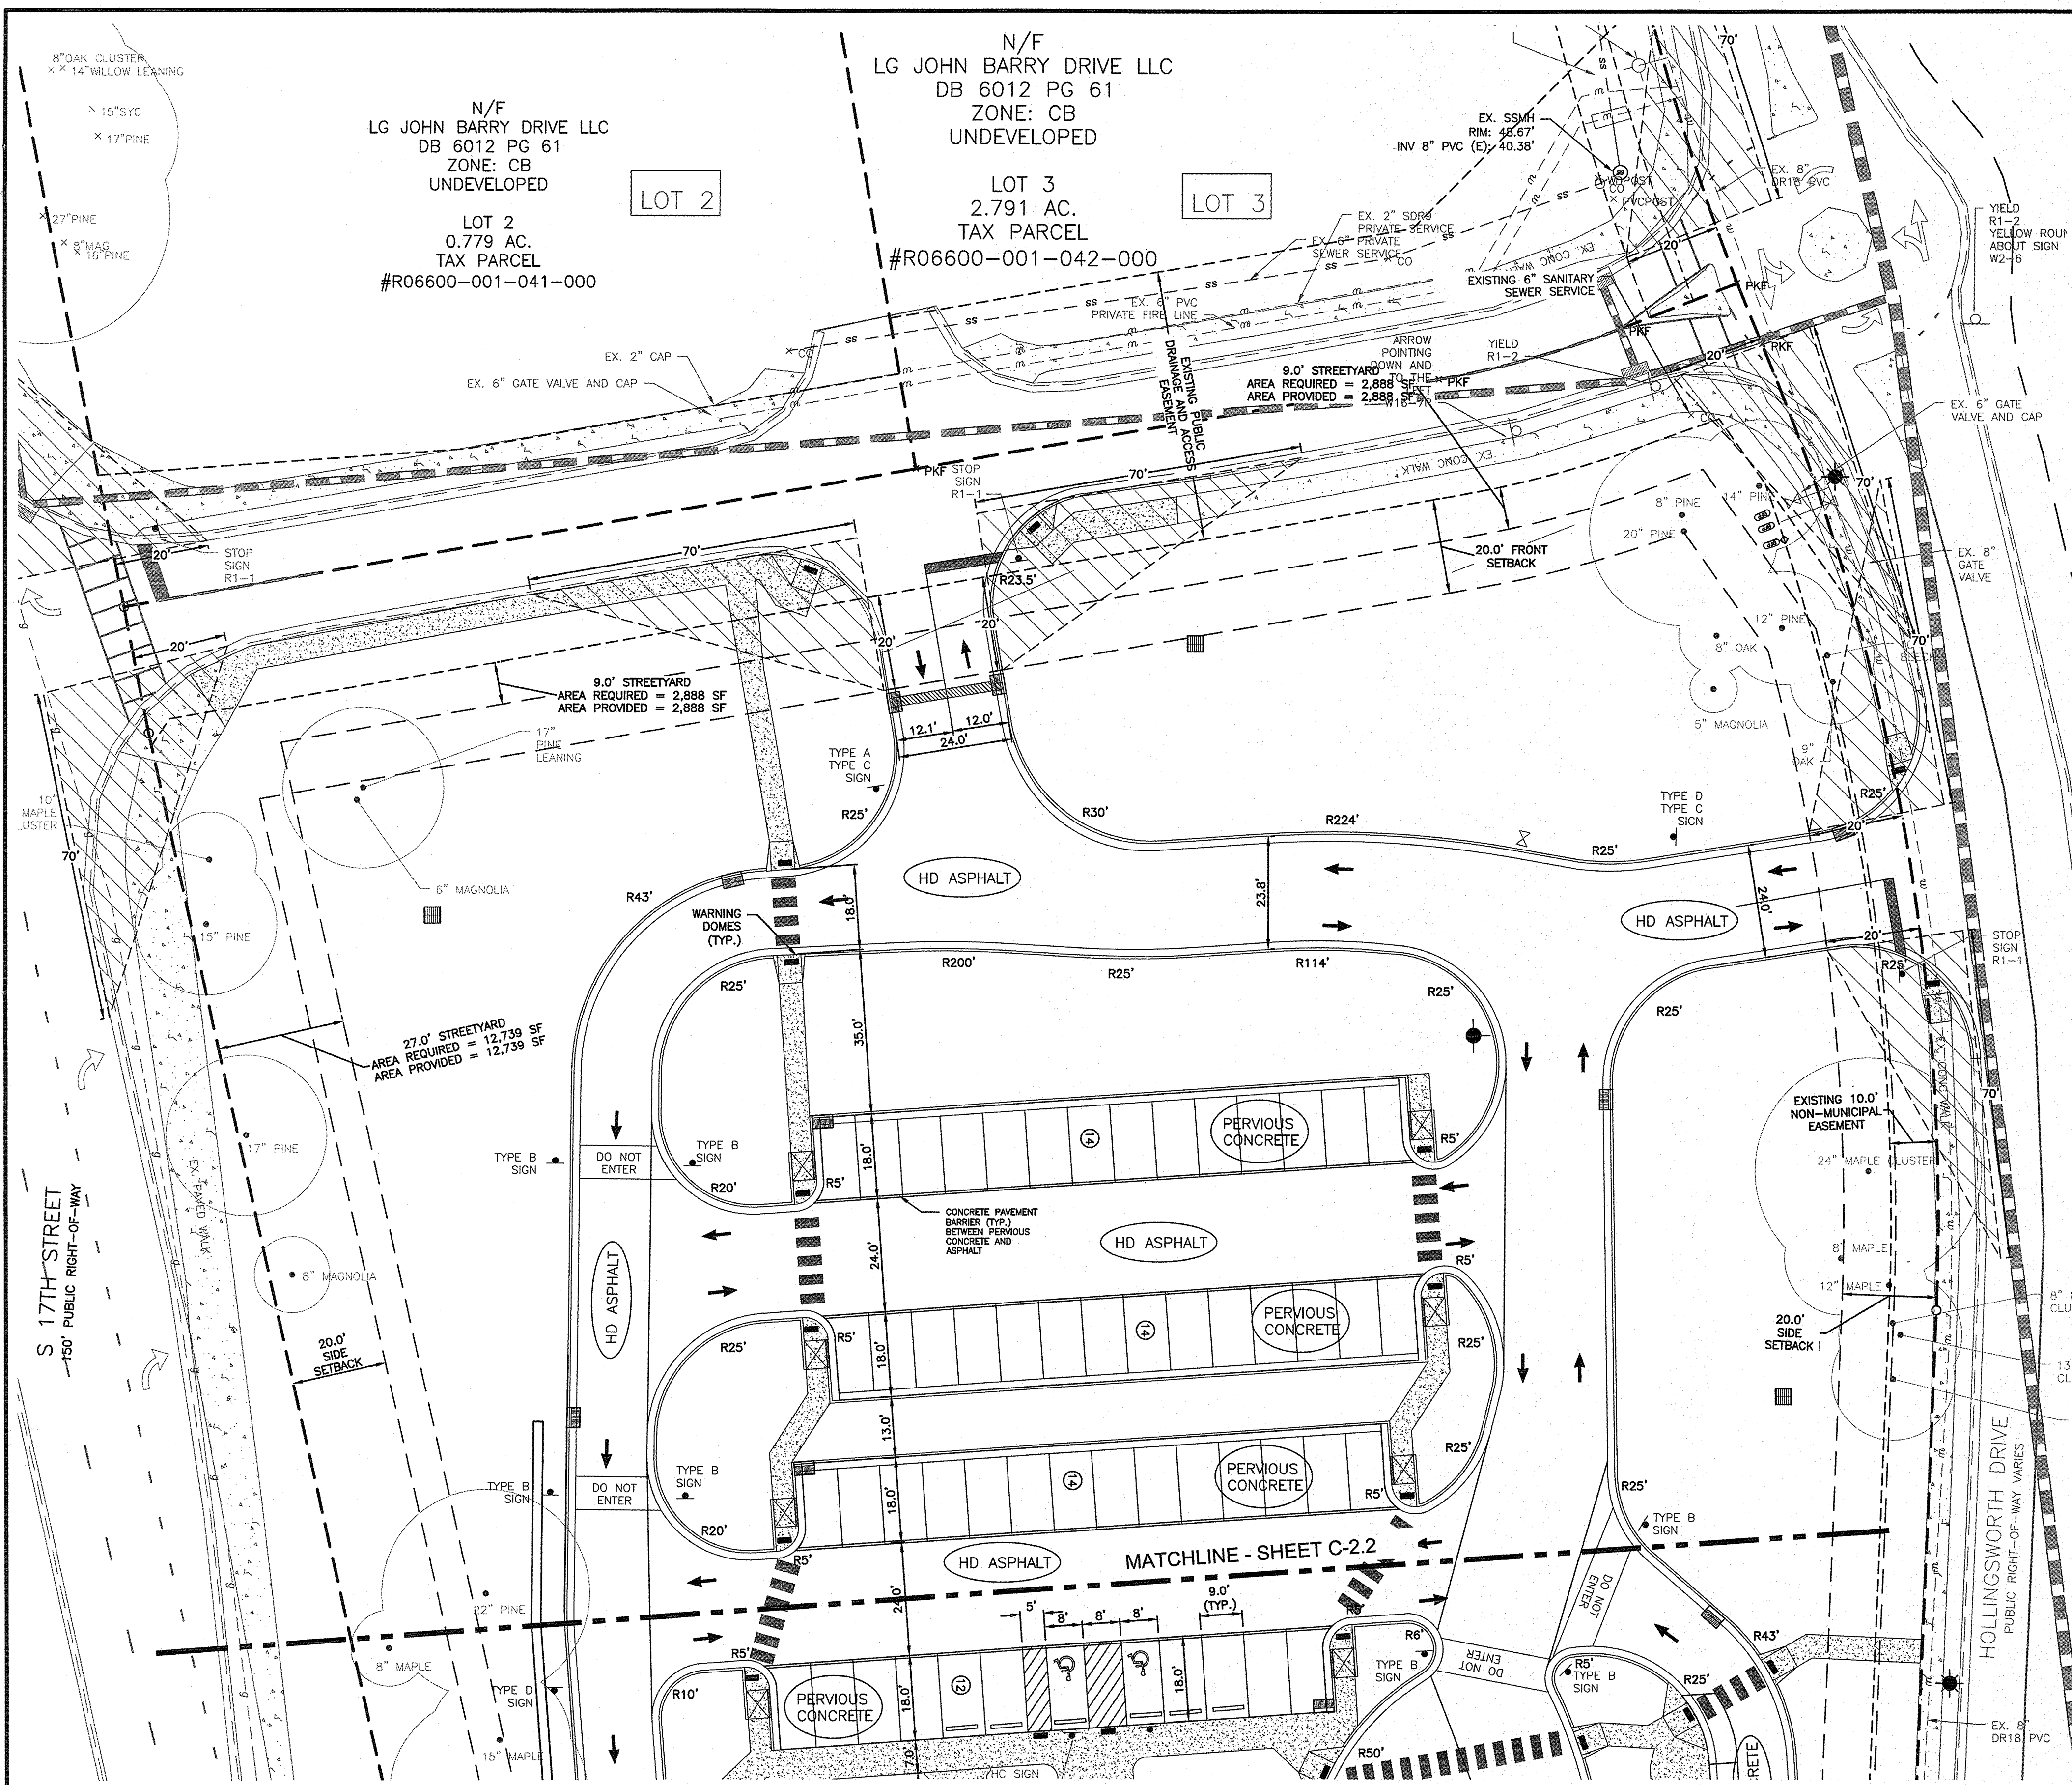

SITE INVENTORY TABLE	
PID:	R06600-01-005-012 (LOT 1) R06600-01-041-000 (LOT 2) R06600-01-042-000 (LOT 3) R06600-01-043-000 (LOT 4)
ZONING (ALL LOTS):	CB-CD
(CITY COUNCIL APPROVED CONDITIONS)	
BUILDING SETBACKS	
FRONT:	20 FT
SIDE:	20 FT
REAR:	10 FT
AREA OF LOT:	3.97 ACRES
BUILDING SIZE	
BRANCH BUILDING:	8,526 SQ FT
REMOTE ATM KIOSK:	96 SQ FT
TOTAL:	8,622 SQ FT
BUILDING FOOTPRINT	
BRANCH BUILDING:	10,099 SQ FT
REMOTE ATM KIOSK:	107 SQ FT
TOTAL:	10,206 SQ FT
BUILDING LOT COVERAGE	10,206 SQ FT / 3.97 ACRES:
5.9%	
NUMBER OF UNITS:	N/A
NUMBER OF BUILDINGS:	1
BUILDING HEIGHT:	34 FT
NUMBER OF STORIES:	3
FIRST FLOOR:	8,399
MEZZANINE:	715
IMPERVIOUS AREA	
PRE DEVELOPMENT:	0 SF
POST DEVELOPMENT:	0% (LOT 1) 66,921 SF 39%
BUILDING TYPE:	5B
HANDICAP:	48
TREE CALCULATIONS:	
REQUIRED:	21
MIN 1SP/400SF:	43
MAX 1SP/200SF:	
STANDARD:	52
HANDICAP:	2
TOTAL:	54
CITY OF WILMINGTON PLANNING STAFF APPROVED 25% PARKING SPACE QUANTITY OVER MAX ALLOWED PER SEC. 18-528 (d) ON SEPTEMBER 10, 2019	
CAMA LAND CLASSIFICATION:	URBAN
CAMA AEC AND SETBACKS:	NONE
HISTORICAL OR ARCHAEOLOGICAL SITES:	NONE
CEMETERY:	NONE
WETLANDS:	NONE
ENDANGERED SPECIES OR HABITAT:	NONE
CONSERVATION AREAS:	NONE
MEAN HIGH WATER LINE:	NONE
WATER SHED:	BARNARD'S CREEK
RIVER BASIN:	CAPE FEAR RIVER
EXISTING OR PROPOSED THROUGHFARES:	NONE
BIKE ROUTES:	NONE
PEDESTRIAN SIDEWALKS:	AS SHOWN
TRANSIT FACILITIES:	NONE
SOIL TYPE:	LEON SAND;MURVILLEFINE SAND;RIMINI SAND,1 TO 6 PERCENT SLOPES

SITE:

- EXISTING BOLLARD
- PROPOSED BOLLARD
- EXISTING SIGN
- EXISTING SIGN, RELOCATED
- PROPOSED SIGN
- FRENCH DRAIN STONE
- PROPOSED SIDEWALK
- SIGHT TRIANGLES
- EXISTING ROOT PROTECTION ZONE

ENGINEER NOTES

1. PRIOR TO ANY CLEARING, GRADING OR CONSTRUCTION ACTIVITY, TREE PROTECTION FENCING SHALL BE INSTALLED AROUND PROTECTED TREES OR GROVES OF TREES. NO CONSTRUCTION WORKERS, TOOLS, MATERIALS, OR VEHICLES ARE PERMITTED WITHIN THE TREE PROTECTION FENCING.
2. ANY TREES AND/OR AREAS DESIGNATED TO BE PROTECTED MUST BE PROPERLY BARRICADED WITH FENCING AND PROTECTED THROUGHOUT CONSTRUCTION TO ENSURE THAT NO CLEARING, GRADING OR STAGING OF MATERIALS WILL OCCUR IN THOSE AREAS.
3. NO EQUIPMENT IS ALLOWED ON SITE UNTIL ALL TREE PROTECTION FENCING AND SILT FENCING IS INSTALLED AND APPROVED. PROTECTIVE FENCING IS TO BE MAINTAINED THROUGHOUT THE DURATION OF THE PROJECT, AND CONTRACTORS SHALL RECEIVE ADEQUATE INSTRUCTION ON TREE PROTECTION METHODS.
4. ALL PAVEMENT MARKINGS IN PUBLIC RIGHTS-OF-WAY AND FOR DRIVEWAYS ARE TO BE THERMOPLASTIC AND MEET CITY AND/OR NCDOT STANDARDS.
5. ONCE STREETS ARE OPEN TO TRAFFIC, CONTACT TRAFFIC ENGINEERING REGARDING THE INSTALLATION OF TRAFFIC AND STREET NAME SIGNS. PROPOSED STREET NAMES MUST BE APPROVED PRIOR TO INSTALLATION OF STREET NAME SIGNS.
6. TRAFFIC CONTROL DEVICES (INCLUDING SIGNS AND PAVEMENT MARKINGS) IN AREAS OPEN TO PUBLIC TRAFFIC ARE TO MEET MUTCD (MANUAL ON UNIFORM TRAFFIC CONTROL DEVICES) STANDARDS.
7. CONTACT TRAFFIC ENGINEERING AT 910-341-7888 TO ENSURE THAT ALL TRAFFIC SIGNAL FACILITIES AND EQUIPMENT ARE SHOWN ON THE PLAN.
8. CALL TRAFFIC ENGINEERING AT 910-341-7888 FORTY-EIGHT (48) HOURS PRIOR TO ANY EXCAVATION IN THE RIGHT-OF-WAY.
9. TRAFFIC ENGINEERING MUST APPROVE OF PAVEMENT MARKING PRIOR TO ACTUAL STRIPING.
10. ALL PARKING STALL MARKINGS AND LANE ARROWS WITHIN THE PARKING AREAS SHALL BE WHITE.
11. ALL TRAFFIC CONTROL SIGNS AND MARKINGS OFF THE RIGHT-OF-WAY ARE TO BE MAINTAINED BY THE PROPERTY OWNER.
12. STOP SIGNS AND STREET SIGNS TO REMAIN IN PLACE DURING CONSTRUCTION.
13. TACTILE WARNING MATS WILL BE INSTALLED ON ALL WHEELCHAIR RAMPS.
14. A UTILITY CUT PERMIT IS REQUIRED FOR EACH OPEN CUT OF A CITY STREET.
15. ANY BROKEN OR MISSING SIDEWALK PANELS, DRIVEWAY PANELS AND CURBING WILL BE REPLACED.
16. CONTACT TRAFFIC ENGINEERING AT (910) 341-7888 TO DISCUSS STREET LIGHTING OPTIONS.
17. WATER AND SEWER SERVICE SHALL MEET CAPE FEAR PUBLIC UTILITY AUTHORITY (CFPUA) DETAILS AND SPECIFICATIONS.
18. PROJECT SHALL COMPLY WITH CFPUA CROSS CONNECTION CONTROL REQUIREMENTS. WATER METER(S) CANNOT BE RELEASED UNTIL ALL REQUIREMENTS ARE MET AND THE STATE HAS GIVEN THEIR FINAL APPROVAL. CALL 910-343-3910 FOR INFORMATION.
19. IF THE CONTRACTOR DESIRES CFPUA WATER FOR CONSTRUCTION, HE SHALL APPLY IN ADVANCE FOR THIS SERVICE AND MUST PROVIDE A REDUCED PRESSURE ZONE (RPZ) BACKFLOW PREVENTION DEVICE ON THE DEVELOPER'S SIDE OF THE WATER METER BOX.
20. ANY IRRIGATION SYSTEM SUPPLIED BY CFPUA WATER SHALL COMPLY WITH THE CFPUA CROSS CONNECTION CONTROL REGULATIONS. CALL 910-343-3910 FOR INFORMATION.
21. ANY IRRIGATION SYSTEM SHALL BE EQUIPPED WITH A RAIN AND FREEZER SENSOR.
22. ANY BACKFLOW PREVENTION DEVICES REQUIRED BY THE CFPUA WILL NEED TO BE ON THE LIST OF APPROVED DEVICES BY USCFCCOHR OR ASSE.
23. CONTRACTOR TO FIELD VERIFY EXISTING WATER AND SEWER SERVICE LOCATIONS, SIZES AND MATERIALS PRIOR TO CONSTRUCTION. ENGINEER TO BE NOTIFIED OF ANY CONFLICTS.
24. CONTRACTOR SHALL MAINTAIN ALL WEATHER ACCESS FOR EMERGENCY VEHICLES AT ALL TIMES DURING CONSTRUCTION.
25. UNDERGROUND FIRE LINE(S) MUST BE PERMITTED AND INSPECTED BY THE WILMINGTON FIRE DEPARTMENT FROM THE PUBLIC RIGHT-OF-WAY TO THE BUILDING. CONTACT THE WILMINGTON FIRE DEPARTMENT DIVISION OF FIRE AND LIFE SAFETY AT 910-341-0696.
26. NO OBSTRUCTIONS ARE PERMITTED IN THE SPACE BETWEEN THIRTY (30) INCHES AND TEN (10) FEET ABOVE THE GROUND WITHIN THE TRIANGULAR SIGHT DISTANCE.
27. CONTACT THE NORTH CAROLINA ONE CALL CENTER AT 1.800.632.4949 PRIOR TO DOING ANY DIGGING, CLEARING, OR GRADING.
28. DRIVEWAY DESIGN MATCHES EXISTING CONDITIONS AND DOES NOT CONFORM TO CITY STANDARDS.
29. NO STREET INTERSECTIONS WITHIN 500' OF SITE.
30. THE MAXIMUM HEIGHT AND AREA OF THE MAIN SIGN ON 17TH STREET IS 20 FEET AND 50 SQUARE FEET RESPECTIVELY.
31. ALL RADII ARE FACE OF CURB.
32. NEW HYDRANTS MUST BE BROUGHT INTO SERVICE [PRIOR TO COMBUSTIBLE MATERIALS DELIVERED TO THE JOB SITE].
33. LANDSCAPING OR PARKING CANNOT BLOCK OR IMPEDE FIRE HYDRANTS. A 3-FOOT CLEAR SPACE SHALL BE MAINTAINED AROUND THE CIRCUMFERENCE OF THE HYDRANT.
34. ADDITIONAL FIRE PROTECTION AND/OR ACCESSIBILITY MAY BE REQUIRED DUE TO ANY SPECIAL CIRCUMSTANCES CONCERNING THE PROJECT.
35. CONTRACTORS SHALL SUBMIT A RADIO SIGNAL STRENGTH STUDY FOR ALL COMMERCIAL BUILDINGS THAT DEMONSTRATE THAT EXISTING FIRE EMERGENCY RESPONDER RADIO SIGNAL LEVELS MEET THE REQUIREMENTS OF SECTION 510 OF THE 2018 FIRE CODE.
36. A LANDSCAPING PLAN INDICATING THE LOCATION OF REQUIRED STREET TREES SHALL BE SUBMITTED TO THE CITY OF WILMINGTON TRAFFIC ENGINEERING DIVISION AND PARKS AND RECREATION DEPARTMENT FOR REVIEW AND PRIOR APPROVAL TO THE RECORDING OF THE FINAL PLAN.
37. STREET TREES MUST BE LOCATED A MINIMUM OF 15 FEET FROM STREET LIGHTS.

Approved Construction Plan

Name: Nicole D Smith Date: 1/30/20

Planning: Nicole D Smith Traffic: W. Smith File: C. W. Smith

Permit: 2020003

Signature: [Signature]


CITY OF WILMINGTON
NORTH CAROLINA

Public Services • Engineering Division

APPROVED STORMWATER MANAGEMENT PLAN

Date: 1/30/2020 Permit: 2020003

Signature: [Signature]

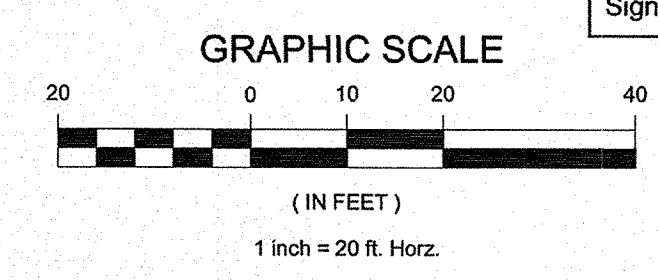

1 GLENWOOD AVE, SUITE 600
RALEIGH, NC 27603
PHONE 919.789.9977

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CHARLOTTE, NC 28262
PHONE 704.714.4880

5030 NEW CENTRE DR., SUITE B
WILMINGTON, NC 28403
PHONE 910.523.5715

seplinc.com

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FOR THE LOCATION OF
UNDERGROUND UTILITIES




THE LOCATION OF EXISTING UNDERGROUND UTILITIES ARE SHOWN IN AN APPROXIMATE MANNER AND ARE NOT BEING INDICATED BY THIS SYMBOL. THE CONTRACTOR SHALL DETERMINE THE EXACT LOCATION OF ALL EXISTING UTILITIES BEFORE COMMENCING WORK, AND AGREE TO BE FULLY RESPONSIBLE FOR ANY AND ALL DAMAGES WHICH MAY BE OCCURRED BY THE CONTRACTOR'S FAILURE TO EXACTLY LOCATE AND PRESERVE ANY AND ALL UNDERGROUND UTILITIES.

NOTICE:
CONSTRUCTION SITE SAFETY IS THE SOLE RESPONSIBILITY OF THE CONTRACTOR. NEITHER THE OWNER NOR THE ENGINEER SHALL BE EXPECTED TO ASSUME ANY RESPONSIBILITY FOR SAFETY OF THE WORK, OR PERSONS ENGAGED IN THE WORK, OR ANY HEAVY STRUCTURES, OR OF ANY OTHER PERSONS.

SEPI ENGINEERING & CONSULTANTS
CORPORATE
SEAL C-2197
N.C.

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<p>OWNER/DEVELOPER/APPLICANT STATE EMPLOYEES' CREDIT UNION</p>	<p>ADDRESS: 119 N. SALISBURY STREET RALEIGH, NORTH CAROLINA 27603 PHONE: 919-639-5300</p>	<p>PROJECT STATE EMPLOYEES' CREDIT UNION - WILMINGTON S 17TH STREET BRANCH</p>	<p>ADDRESS: 4355 S 17TH STREET WILMINGTON NC 28412</p>
<p>CHECKED BY: DM</p>	<p>FIELD SURVEY DATE: 02/15/19</p>	<p>DRAWN BY: KD</p>	<p>DRAWING DATE: 12/03/2019</p>
<p>For each open utility cut of City streets, a \$325 permit shall be required from the City prior to occupancy and/or project acceptance</p>		<p>SHEET C-21</p>	

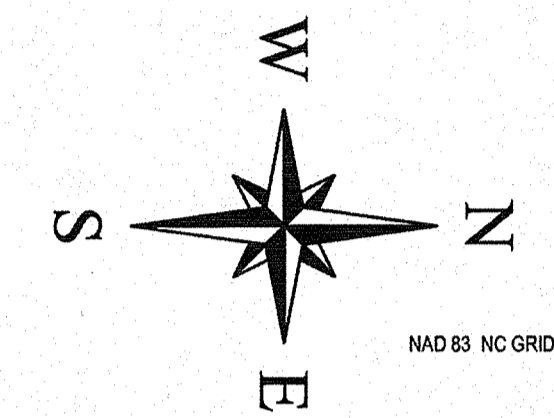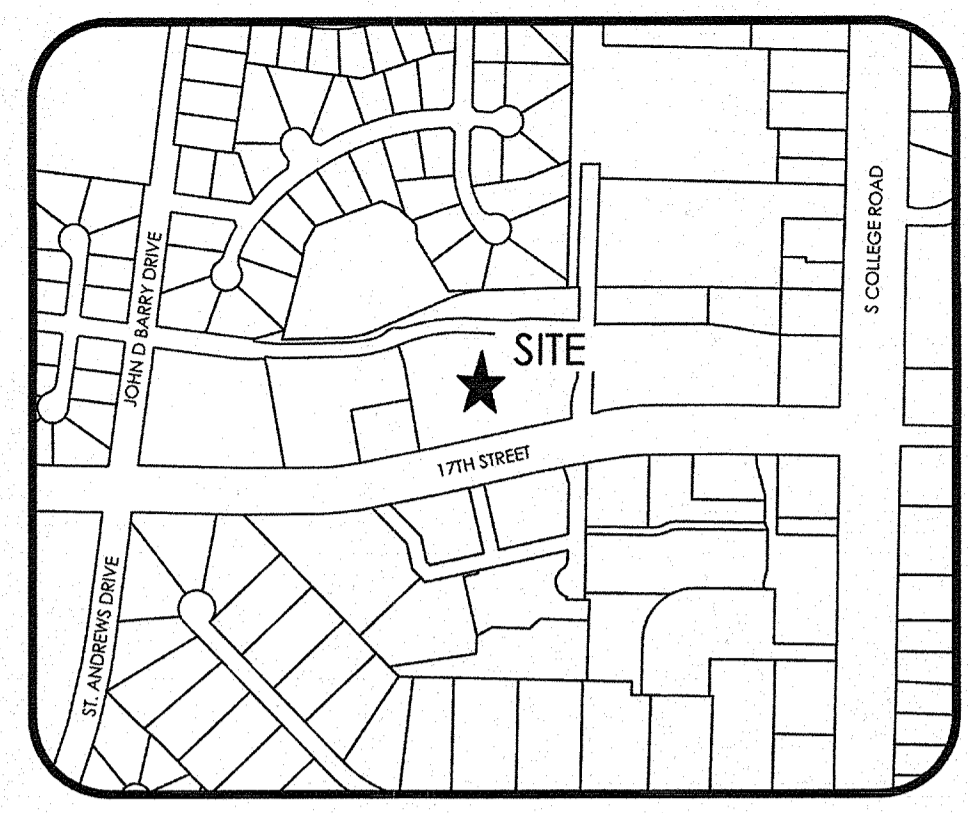
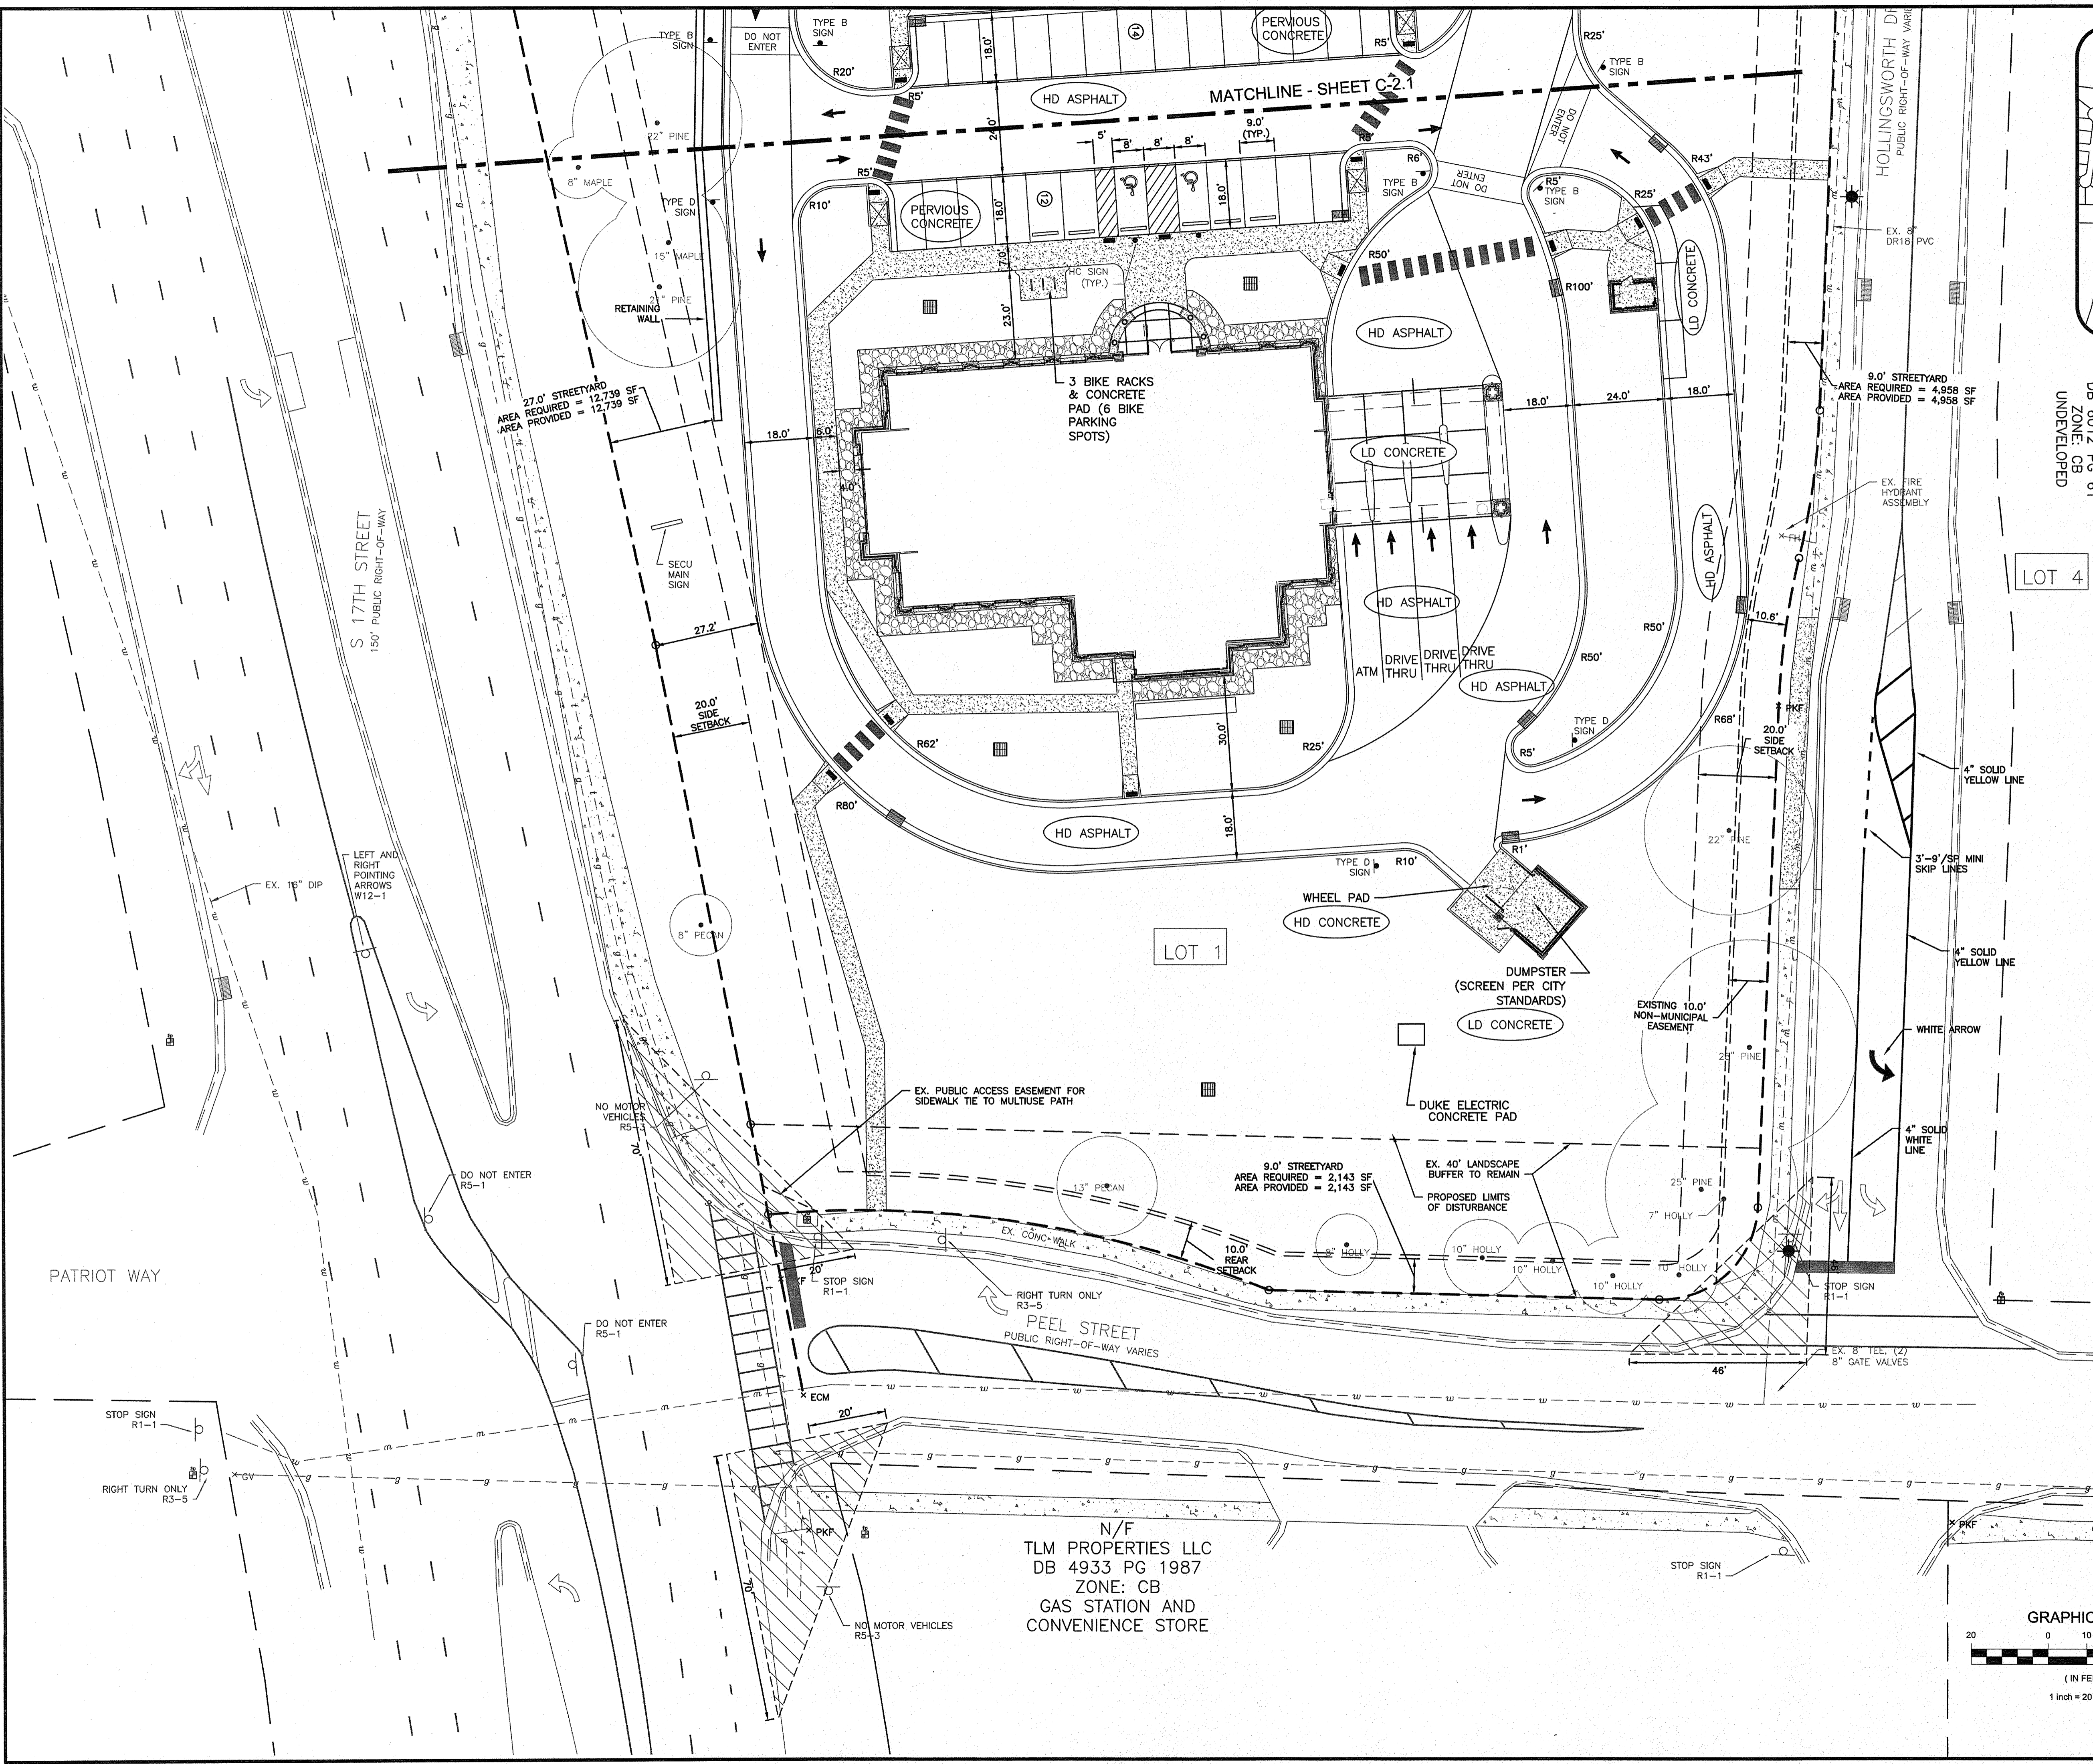


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 5030 NEW CENTRE DR., SUITE B
 WILMINGTON, NC 28403
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 3 WORKING DAYS
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 FOR THE LOCATION OF
 UNDERGROUND FACILITIES

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NOTICE:
 THE CONTRACTOR'S RESPONSIBILITY IS TO VERIFY THE LOCATION OF ALL EXISTING UTILITIES BEFORE COMMENCING WORK. THE CONTRACTOR SHALL BE EXPECTED TO ASSUME ANY RESPONSIBILITY FOR SAFETY OF THE WORK OF PERSONS ENGAGED IN THE WORK OF ANY NEARBY STRUCTURES, OR OF ANY OTHER PERSONS.



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OWNER/DEVELOPER/APPLICANT
STATE EMPLOYEES' CREDIT UNION
 ADDRESS:
 119 N. SALISBURY STREET
 RALEIGH, NORTH CAROLINA 27603
 PHONE: 919-839-5300

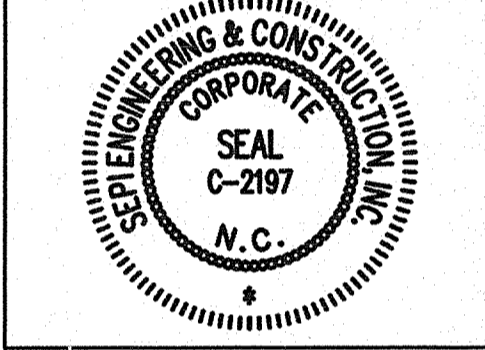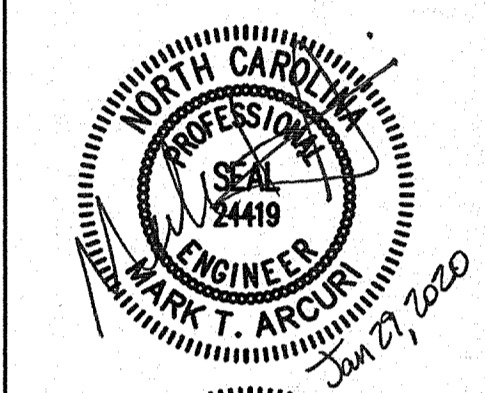
PROJECT
STATE EMPLOYEES' CREDIT UNION - WILMINGTON S 17th STREET BRANCH
 ADDRESS:
 4355 S 17th STREET
 WILMINGTON NC 28412

PROJECT MANAGER MTA	FIELD SURVEY DATE: 02/16/19
CHECKED BY: DM	DRAWING DATE: 12/08/2019
DRAWN BY: KD	JOB #: SE1819100
SHEET	

Approved Construction Plan
 Name: Nicole Lynith Date: 1/30/20
 Planning: W 3700-1-30-20
 Traffic: C. Wile 1/30/20
 Fire: C. Wile 1/30/20

CITY OF WILMINGTON
 NORTH CAROLINA
 Public Services • Engineering Division
 APPROVED STORMWATER MANAGEMENT PLAN
 Date: 1/30/2020 Permit # 2020003
 Signed: Frank Christman




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N/F
 TLM PROPERTIES LLC
 DB 4933 PG 1987
 ZONE: CB
 GAS STATION AND CONVENIENCE STORE

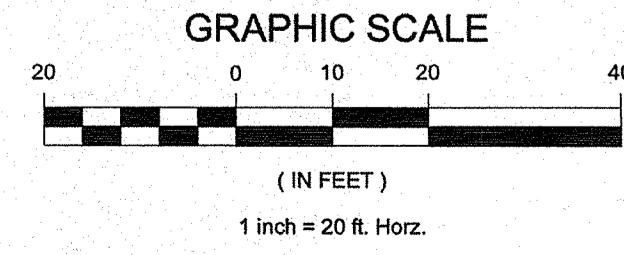DB 6012 PG 61
 ZONE: CB
 UNDEVELOPED
 LOT 4

SITE LAYOUT PLAN



VICINITY MAP
NOT TO SCALE

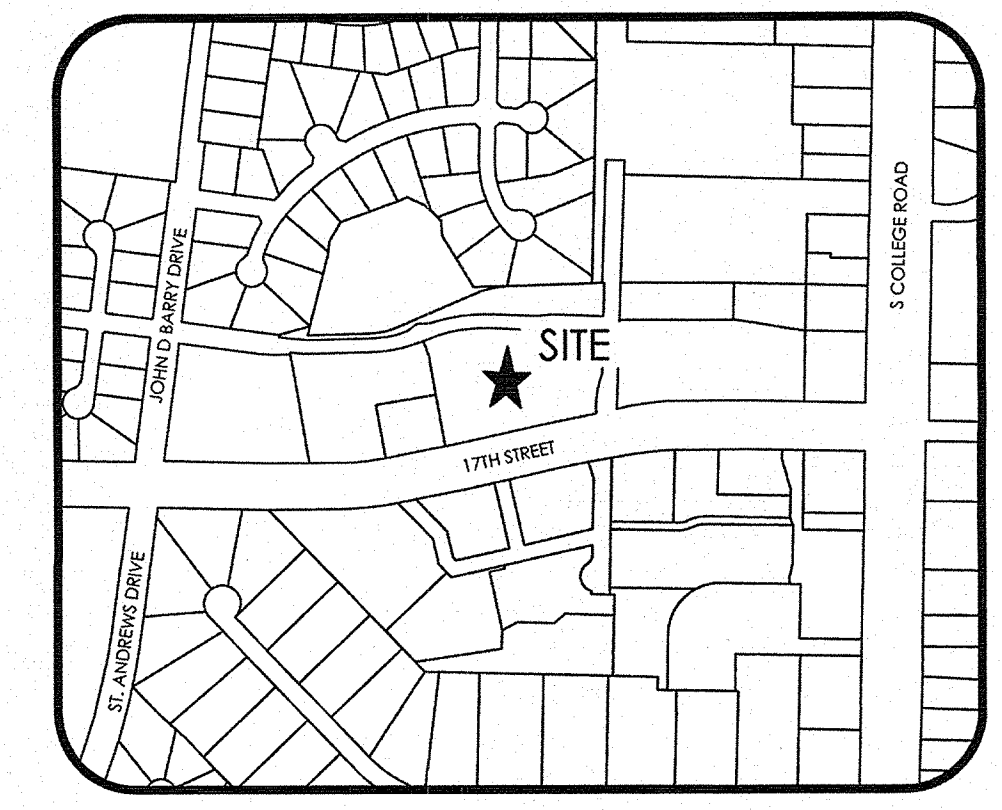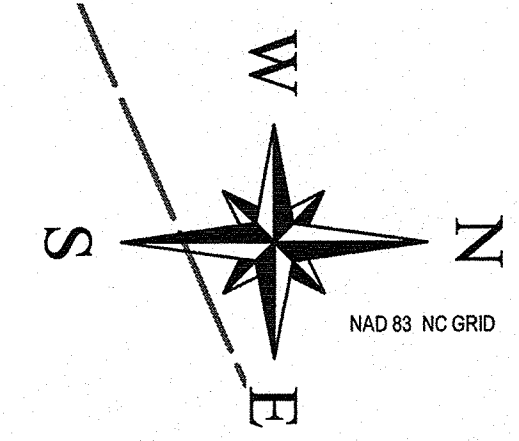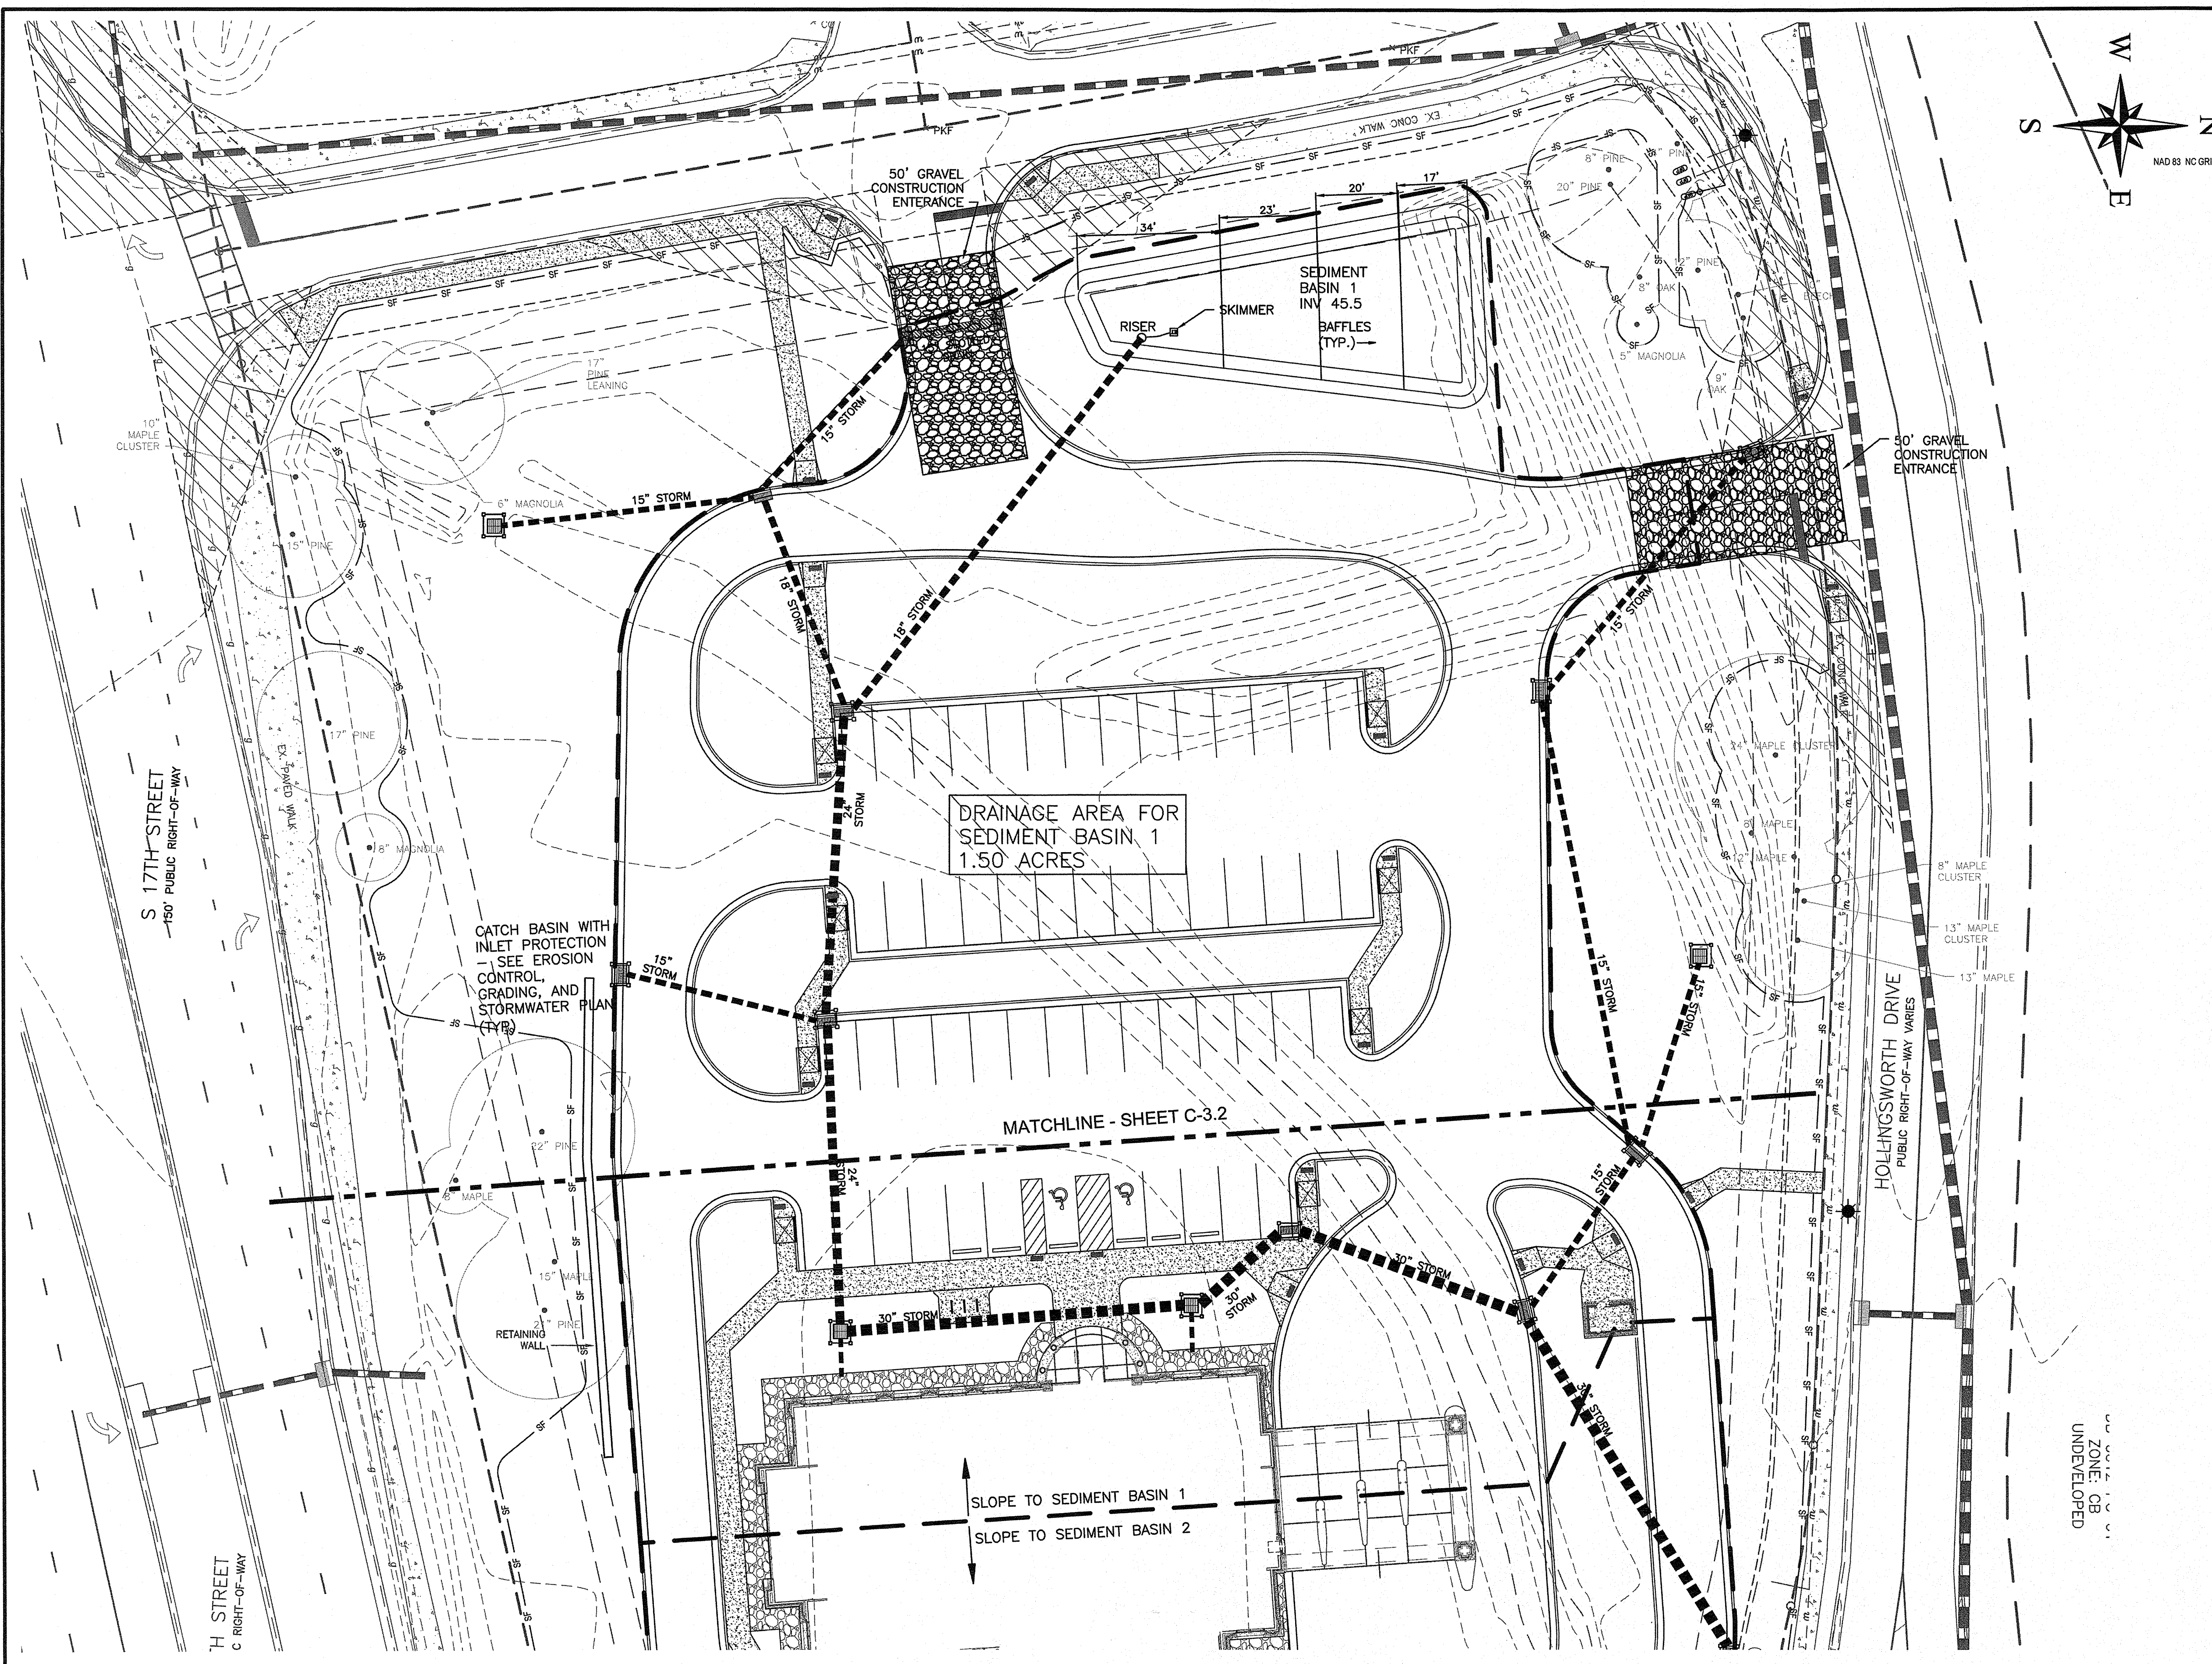GRADING:

EXISTING MINOR CONTOUR	---	39
PROPOSED MINOR CONTOUR	---	39
EXISTING MAJOR CONTOUR	---	40
PROPOSED MAJOR CONTOUR	---	40
EXISTING SPOT ELEVATION	---	× 1.00
PROPOSED SPOT ELEVATION	---	× 1.00
EXISTING GRADE ARROW	---	~
PROPOSED GRADE ARROW	---	~

MISCELLANEOUS:

PROPOSED SILT FENCE	---	SF	SF
PROPOSED LIMITS OF DISTURBANCE	---	LD	LD
INLET PROTECTION	---	[Symbol]	[Symbol]
PROPOSED TREE PROTECTION	---	TP	TP
PROPOSED GRAVEL	---	[Symbol]	[Symbol]

NOTE:
SEE EROSION CONTROL, GRADING, AND STORMWATER PLAN FOR STORM STRUCTURE ELEVATIONS.

Approved Construction Plan

Name: Nicole D Smith Date: 1/30/20

Planning: Nicole D Smith 1-30-20

Traffic: C. Wala


Fire: C. Wala 1/30/20

CITY OF WILMINGTON
NORTH CAROLINA

Public Services • Engineering Division
APPROVED STORMWATER MANAGEMENT PLAN

Date: 1/30/2020 Permit # 2020003

Signed: [Signature]

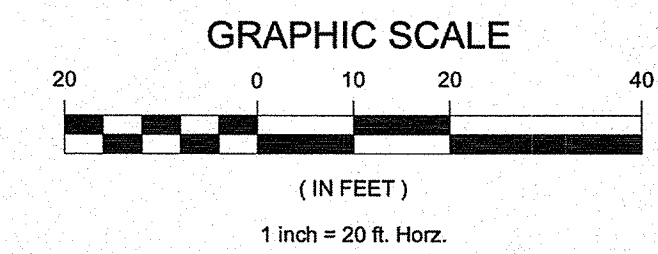

For each open utility cut of City streets, a \$325 permit shall be required from the City prior to occupancy and/or project acceptance

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PHONE 704.714.4880

5030 NEW CENTRE DR., SUITE B
WILMINGTON, NC 28403
PHONE 910.523.5715



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NOTICE:
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OWNER/DEVELOPER/APPLICANT
STATE EMPLOYEES' CREDIT UNION

ADDRESS:
119 N. SALISBURY STREET
RALEIGH, NORTH CAROLINA 27603
PHONE: 919-839-5300

PROJECT MANAGER
STATE EMPLOYEES' CREDIT UNION - WILMINGTON
S 17th STREET BRANCH

ADDRESS:
4355 S 17TH STREET
WILMINGTON NC 28412

PROJECT MANAGER
MTA

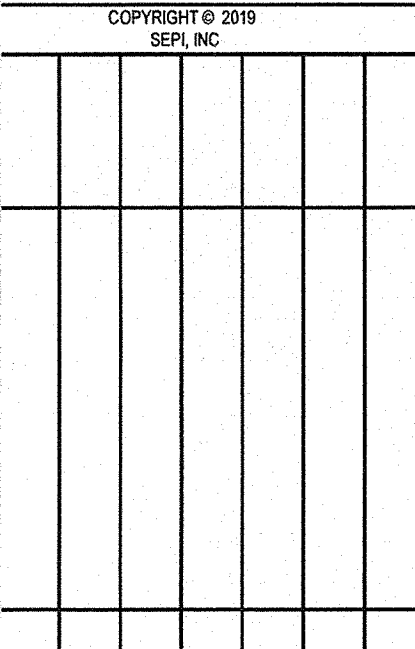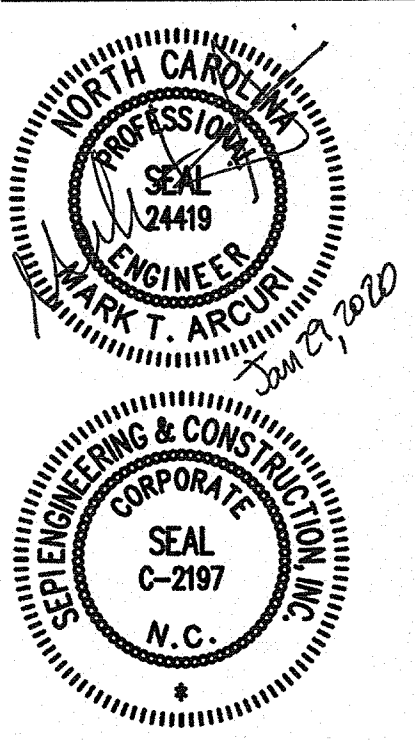FIELD SURVEY DATE:
02/16/19

CHECKED BY:
DM



DRAWING DATE:
12/03/2019

DRAWN BY:
KD


JOB #:
SE18.191.00

SHEET
C-3.1

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VICINITY MAP
NOT TO SCALE

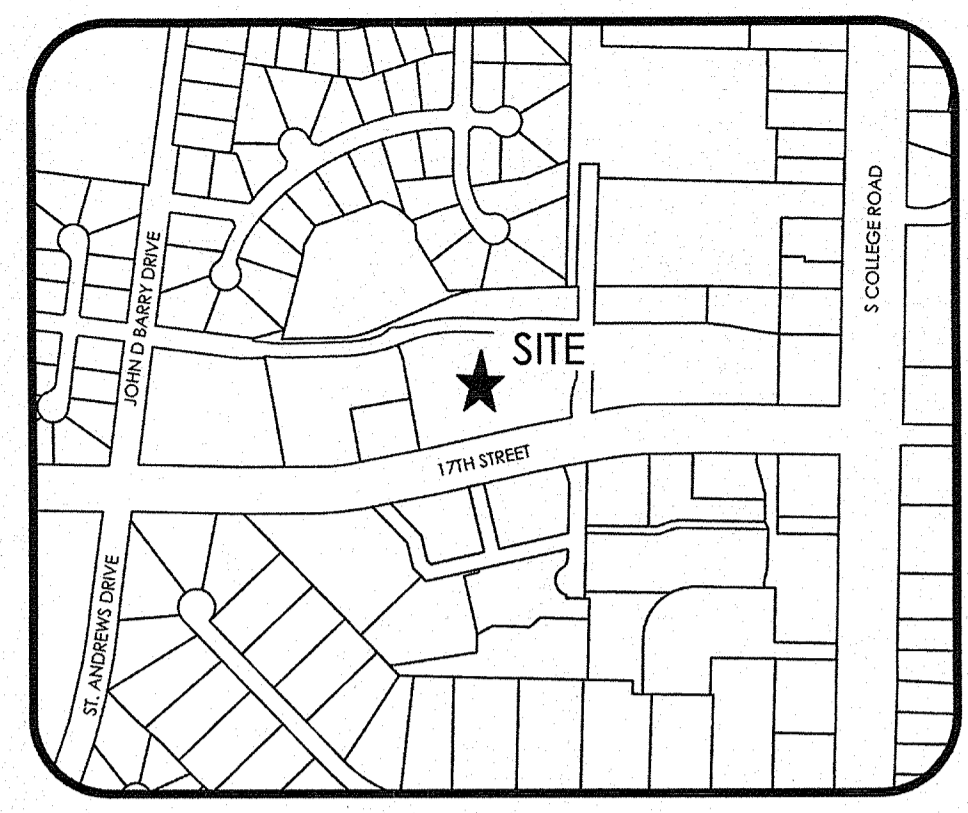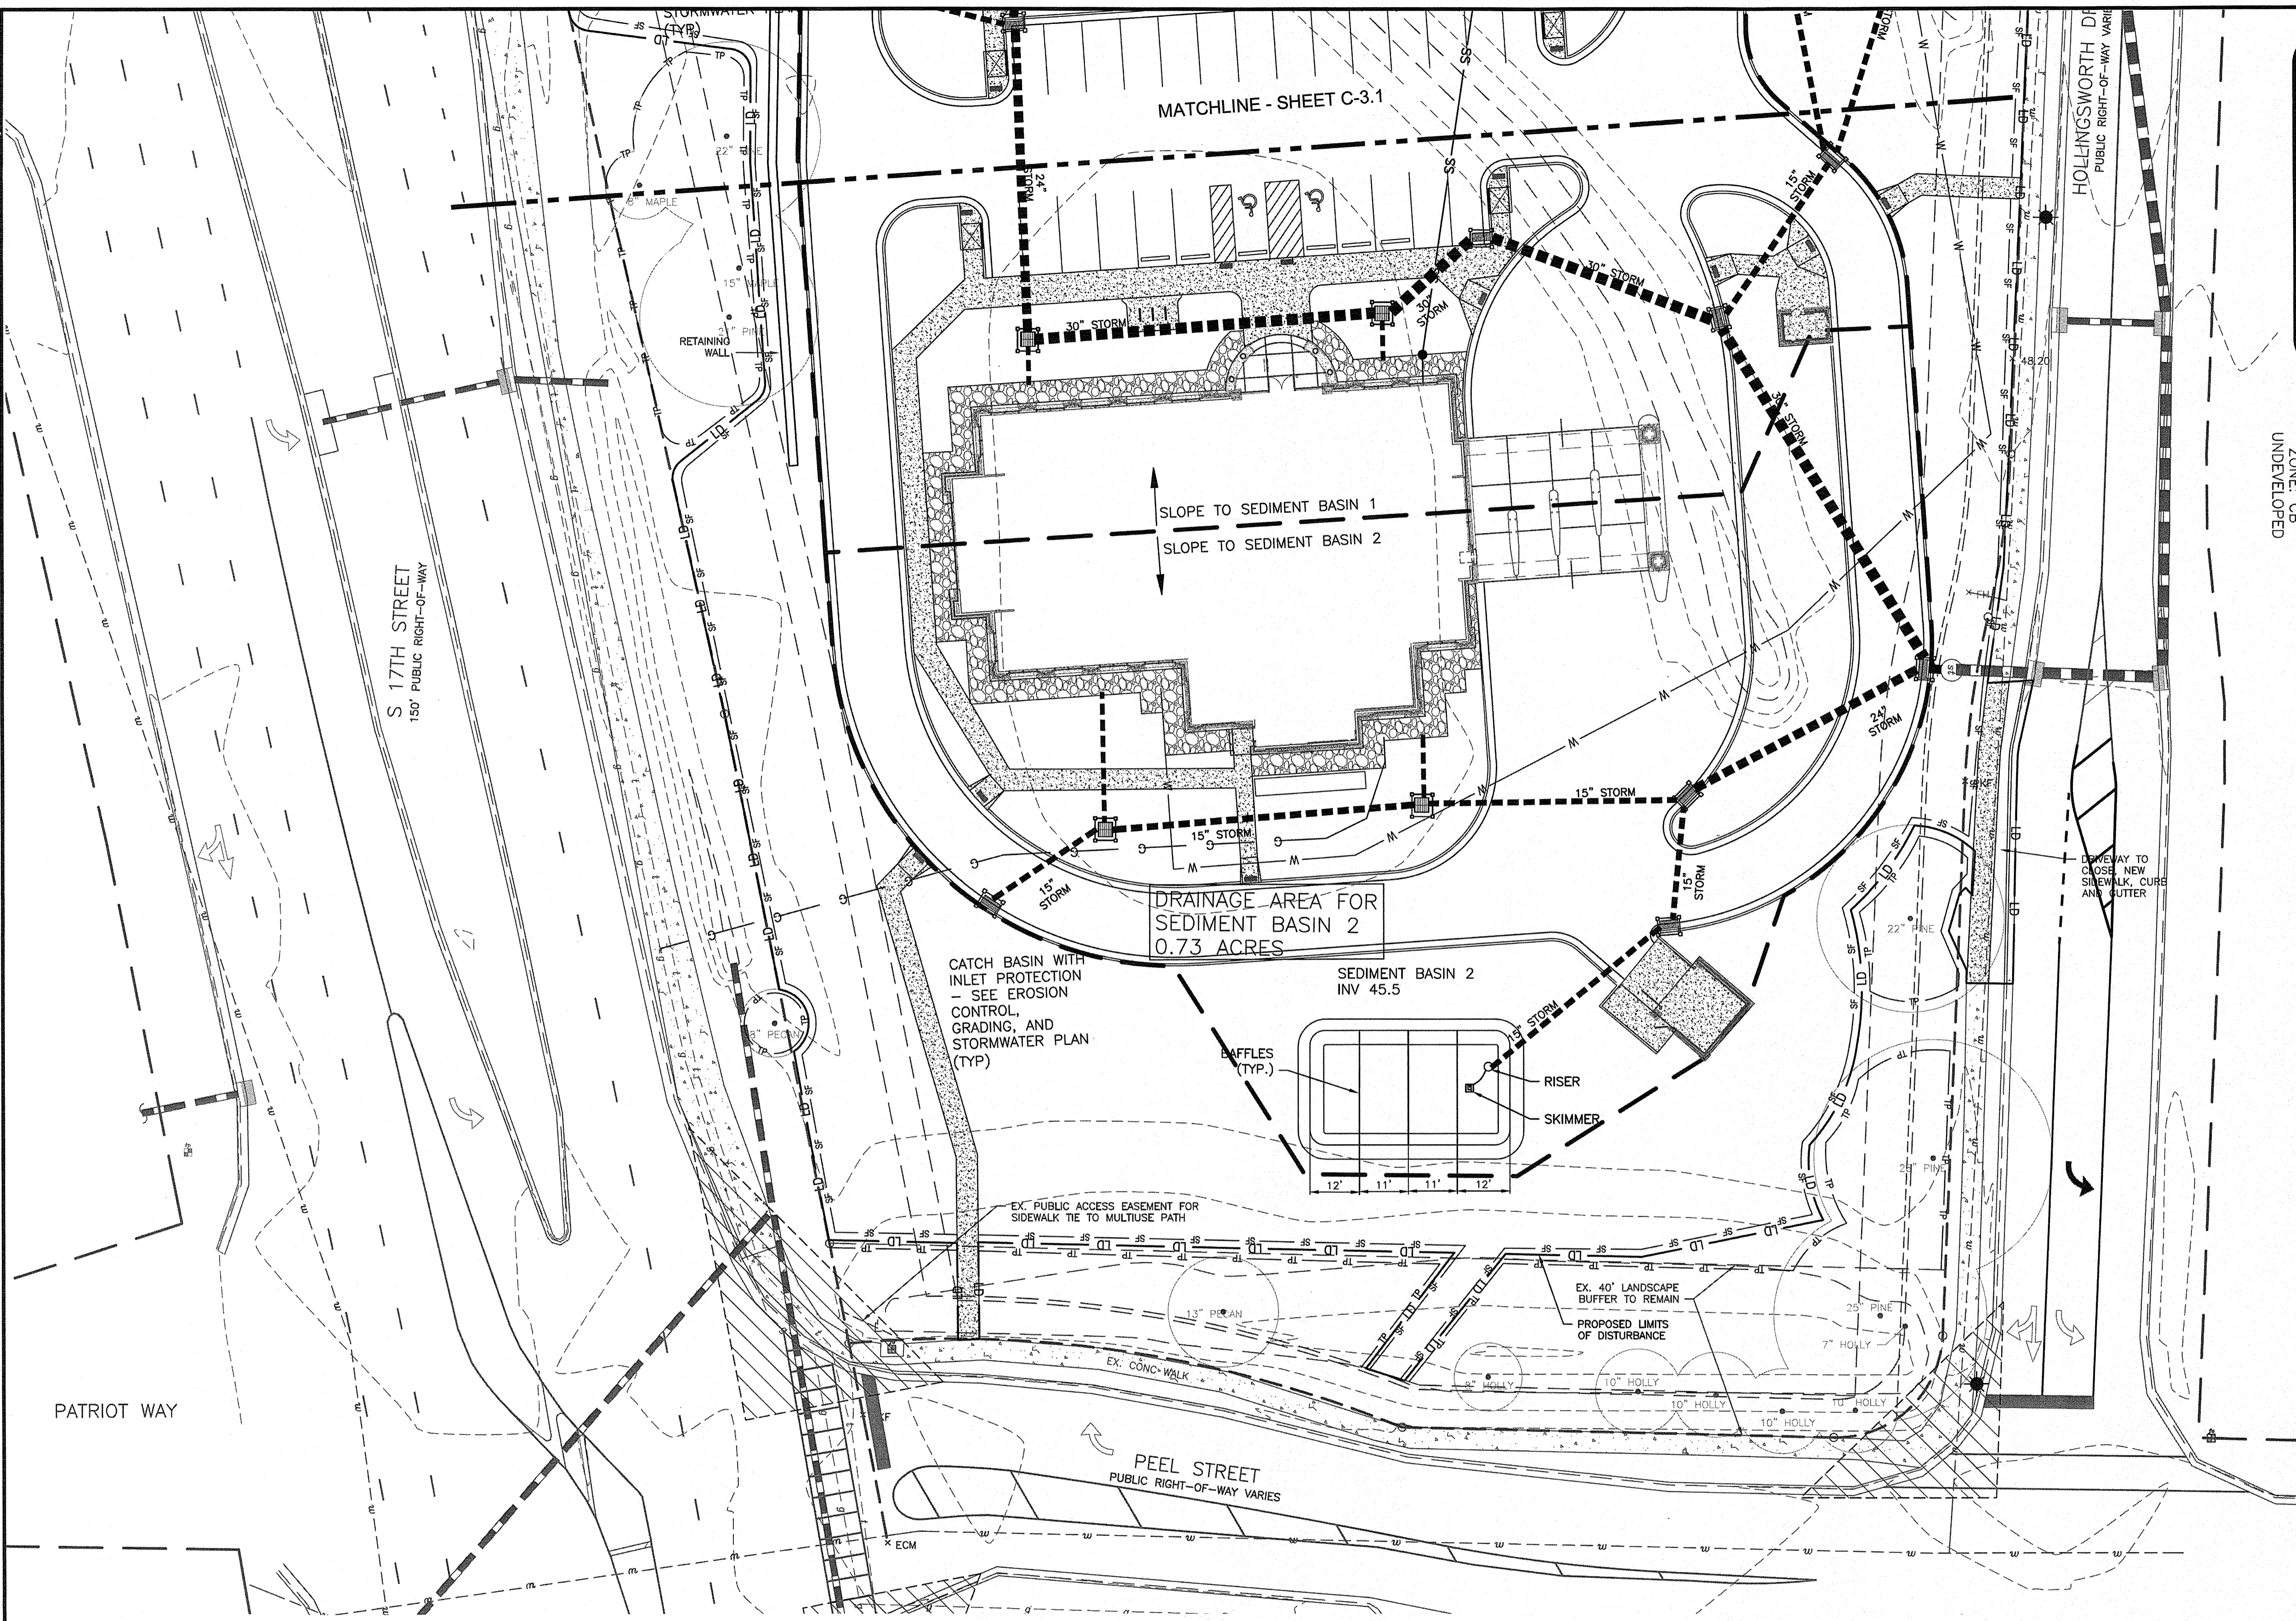

DB 6012 PG. 61
ZONE: CB
UNDEVELOPED


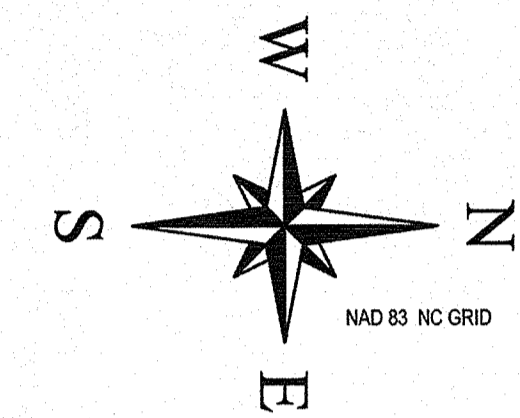
NOTE:
SEE EROSION CONTROL, GRADING, AND STORMWATER PLAN FOR STORM STRUCTURE ELEVATIONS.

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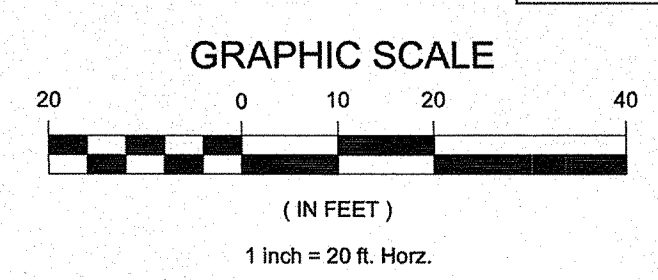
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WORK OF PERSONS ENGAGED IN THE WORK OF ANY NEARBY
STRUCTURES, OR OF ANY OTHER PERSONS.



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Approved Construction Plan	
Name	Date
Planning: Nicole Smith	1/30/20
Traffic: W. Smith	1-30-20
Fire: C. W. W.	1/30/20

CITY OF WILMINGTON
NORTH CAROLINA
Public Services • Engineering Division
APPROVED STORMWATER MANAGEMENT PLAN
Date: 1/30/2020 Permit # 2020003
Signed: *Kash Christman*



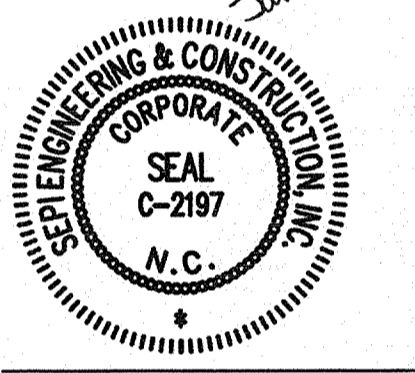
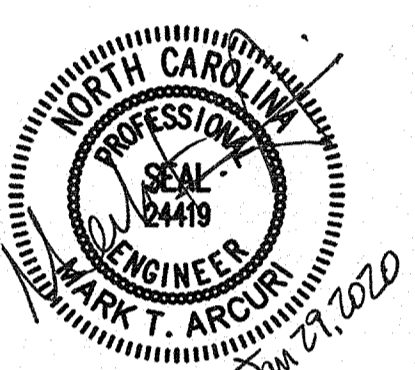


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shall be required from the
City prior to occupancy
and/or project acceptance

OWNER/DEVELOPER/APPLICANT STATE EMPLOYEES' CREDIT UNION	ADDRESS: 119 N. SALISBURY STREET RALEIGH, NORTH CAROLINA 27603 PHONE: 919-839-5300
PROJECT STATE EMPLOYEES' CREDIT UNION - WILMINGTON S 17th STREET BRANCH	ADDRESS: 4355 S 17TH STREET WILMINGTON NC 28412
PROJECT MANAGER MTA	FIELD SURVEY DATE: 02/15/19
CHECKED BY: DM	DRAWING DATE: 12/03/2019
DRAWN BY: KD	JOB #: SE18.191.00
SHEET C-3.2	

TEMPORARY EROSION CONTROL, GRADING, AND STORMWATER

K:\2018\021819100_0219 - Wilmington South 17th Street Branch\Design\Drawings\Site - Plan\20181910003_C-3.2_1910003.dwg, 1/29/2020 14:52:31 PM, jrcat

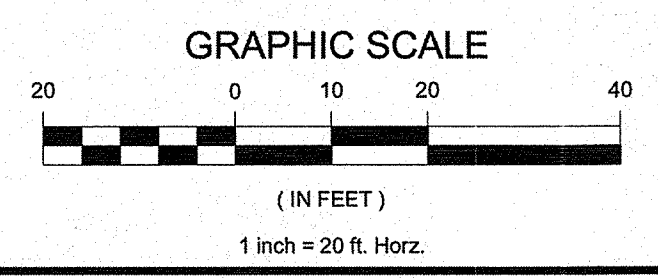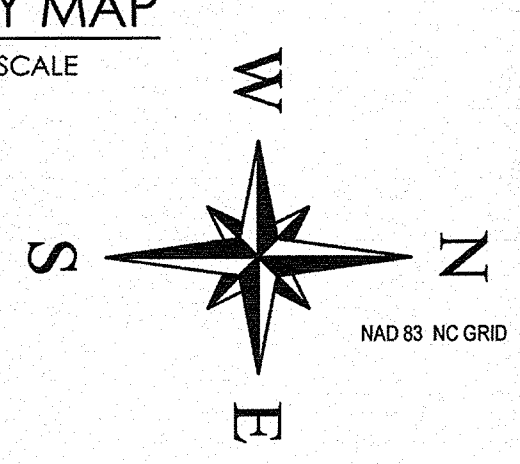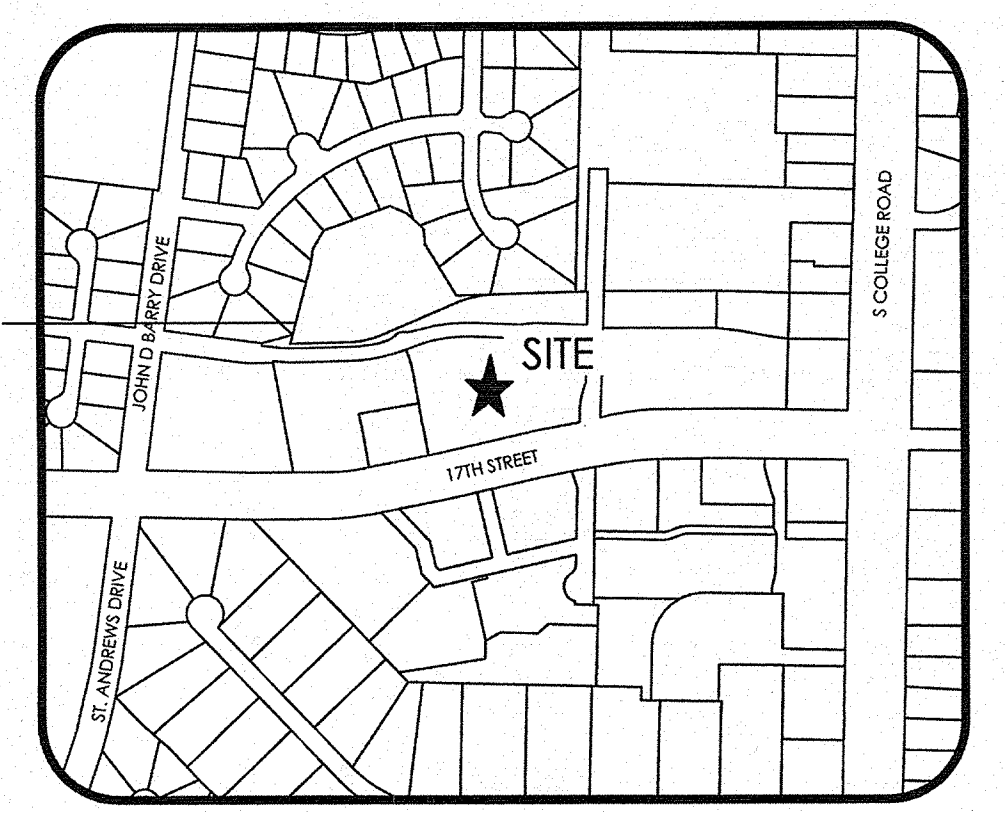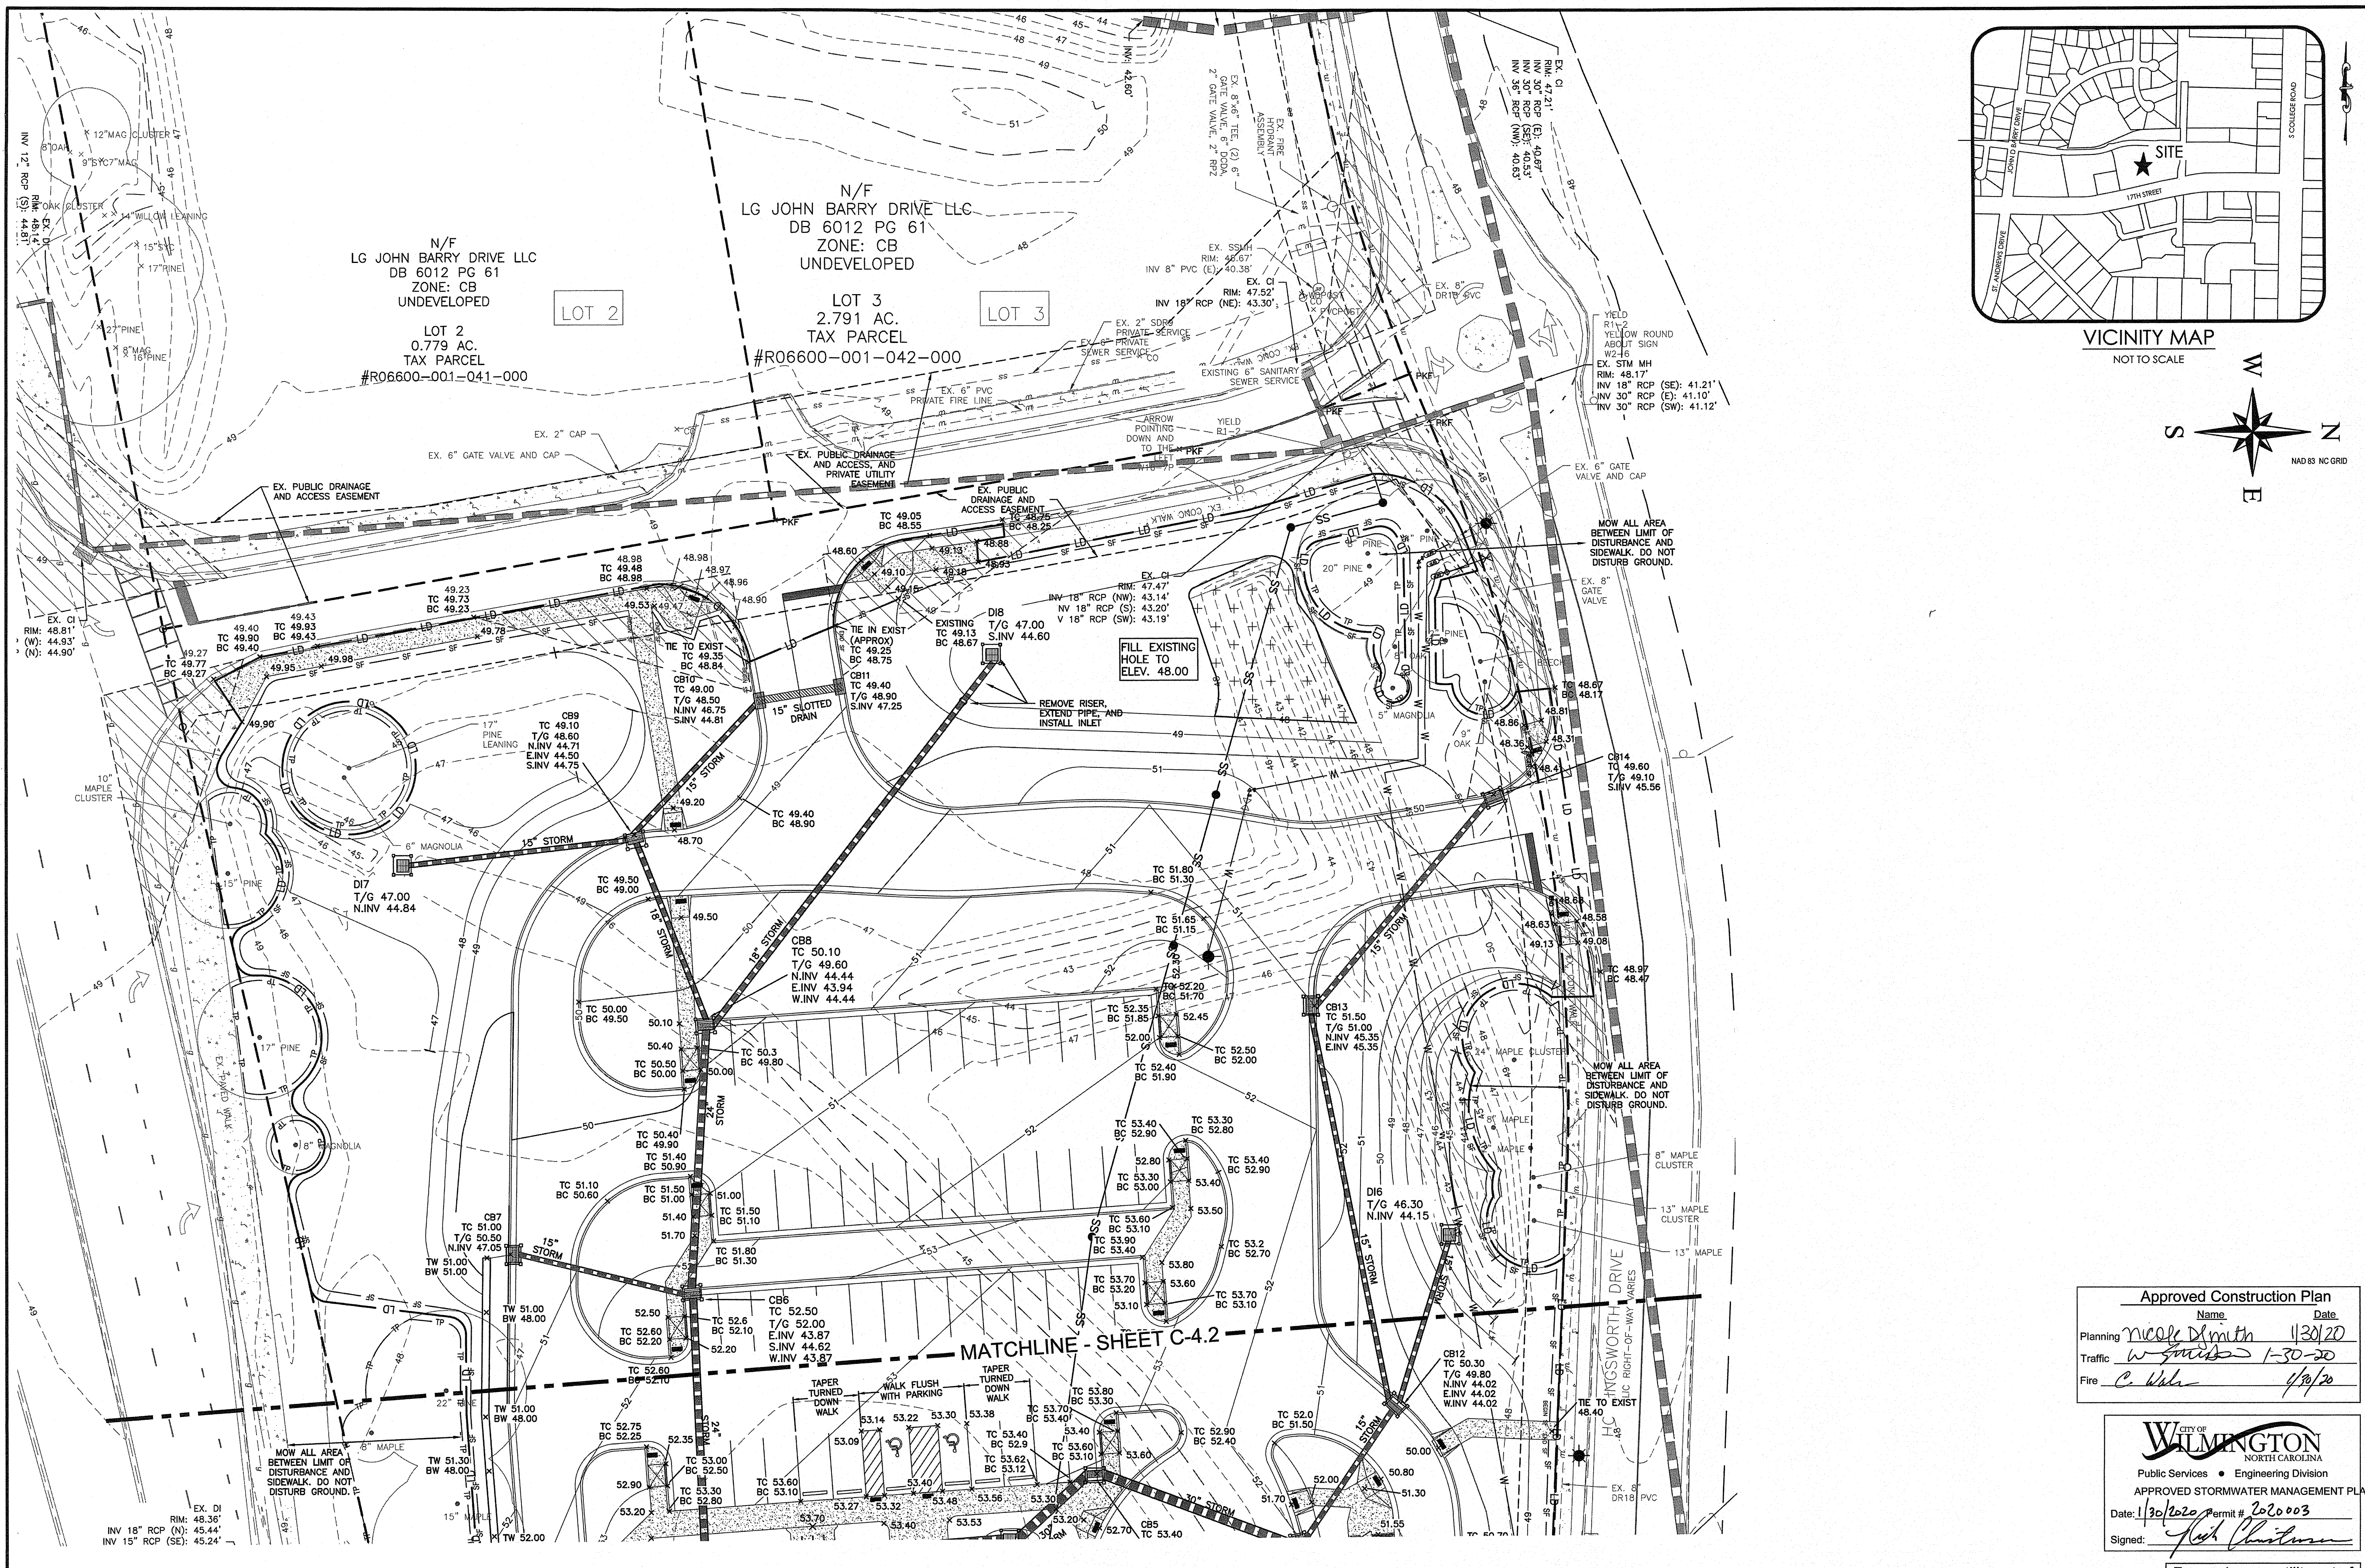

N/F
LG JOHN BARRY DRIVE LLC
DB 6012 PG 61
ZONE: CB
UNDEVELOPED

LOT 2
0.779 AC.
TAX PARCEL
#R06600-001-041-000

N/F
LG JOHN BARRY DRIVE LLC
DB 6012 PG 61
ZONE: CB
UNDEVELOPED

LOT 3
2.791 AC.
TAX PARCEL
#R06600-001-042-000

MATCHLINE - SHEET C-4.2


Approved Construction Plan
Name: Neale D Smith Date: 11/30/20
Planning: W Smith Traffic: 1-30-20 Fire: C. White 4/20/20

CITY OF WILMINGTON
NORTH CAROLINA
Public Services • Engineering Division
APPROVED STORMWATER MANAGEMENT PLAN
Date: 1/30/2020 Permit # 2020003
Signed: John Christman

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PHONE 910.523.5715
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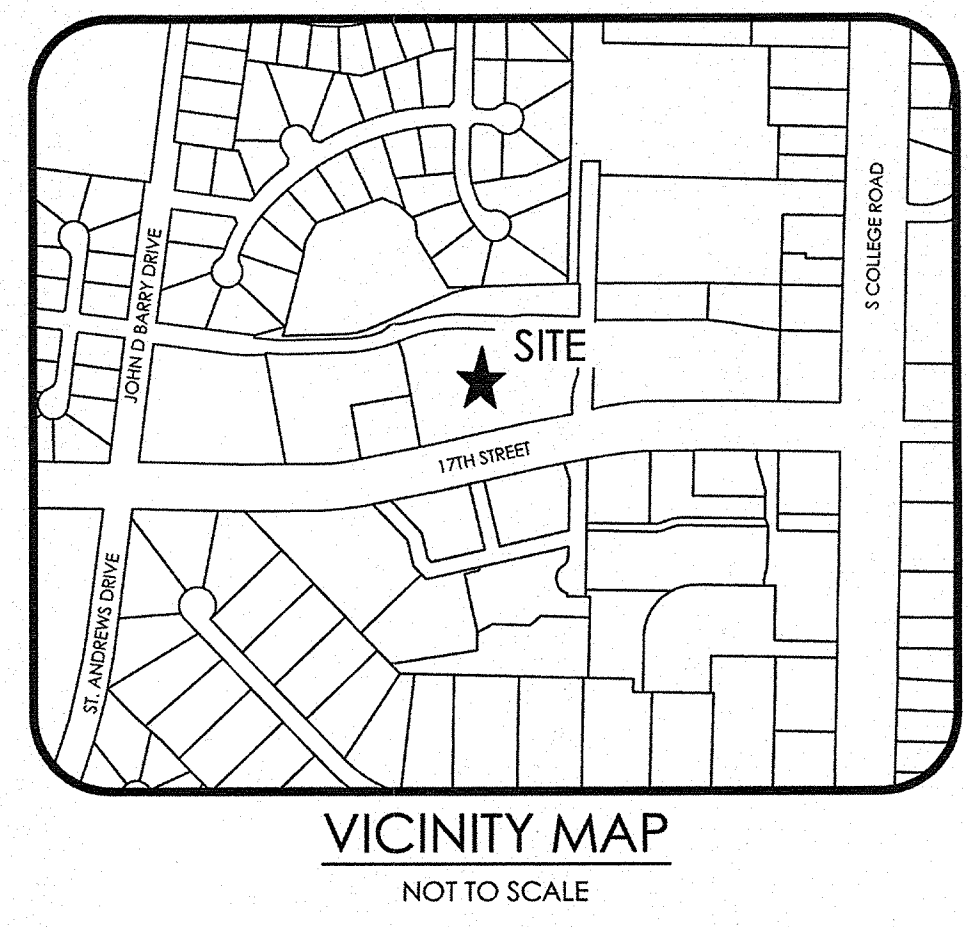
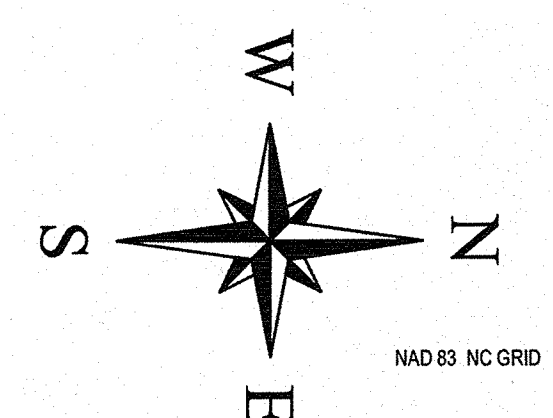
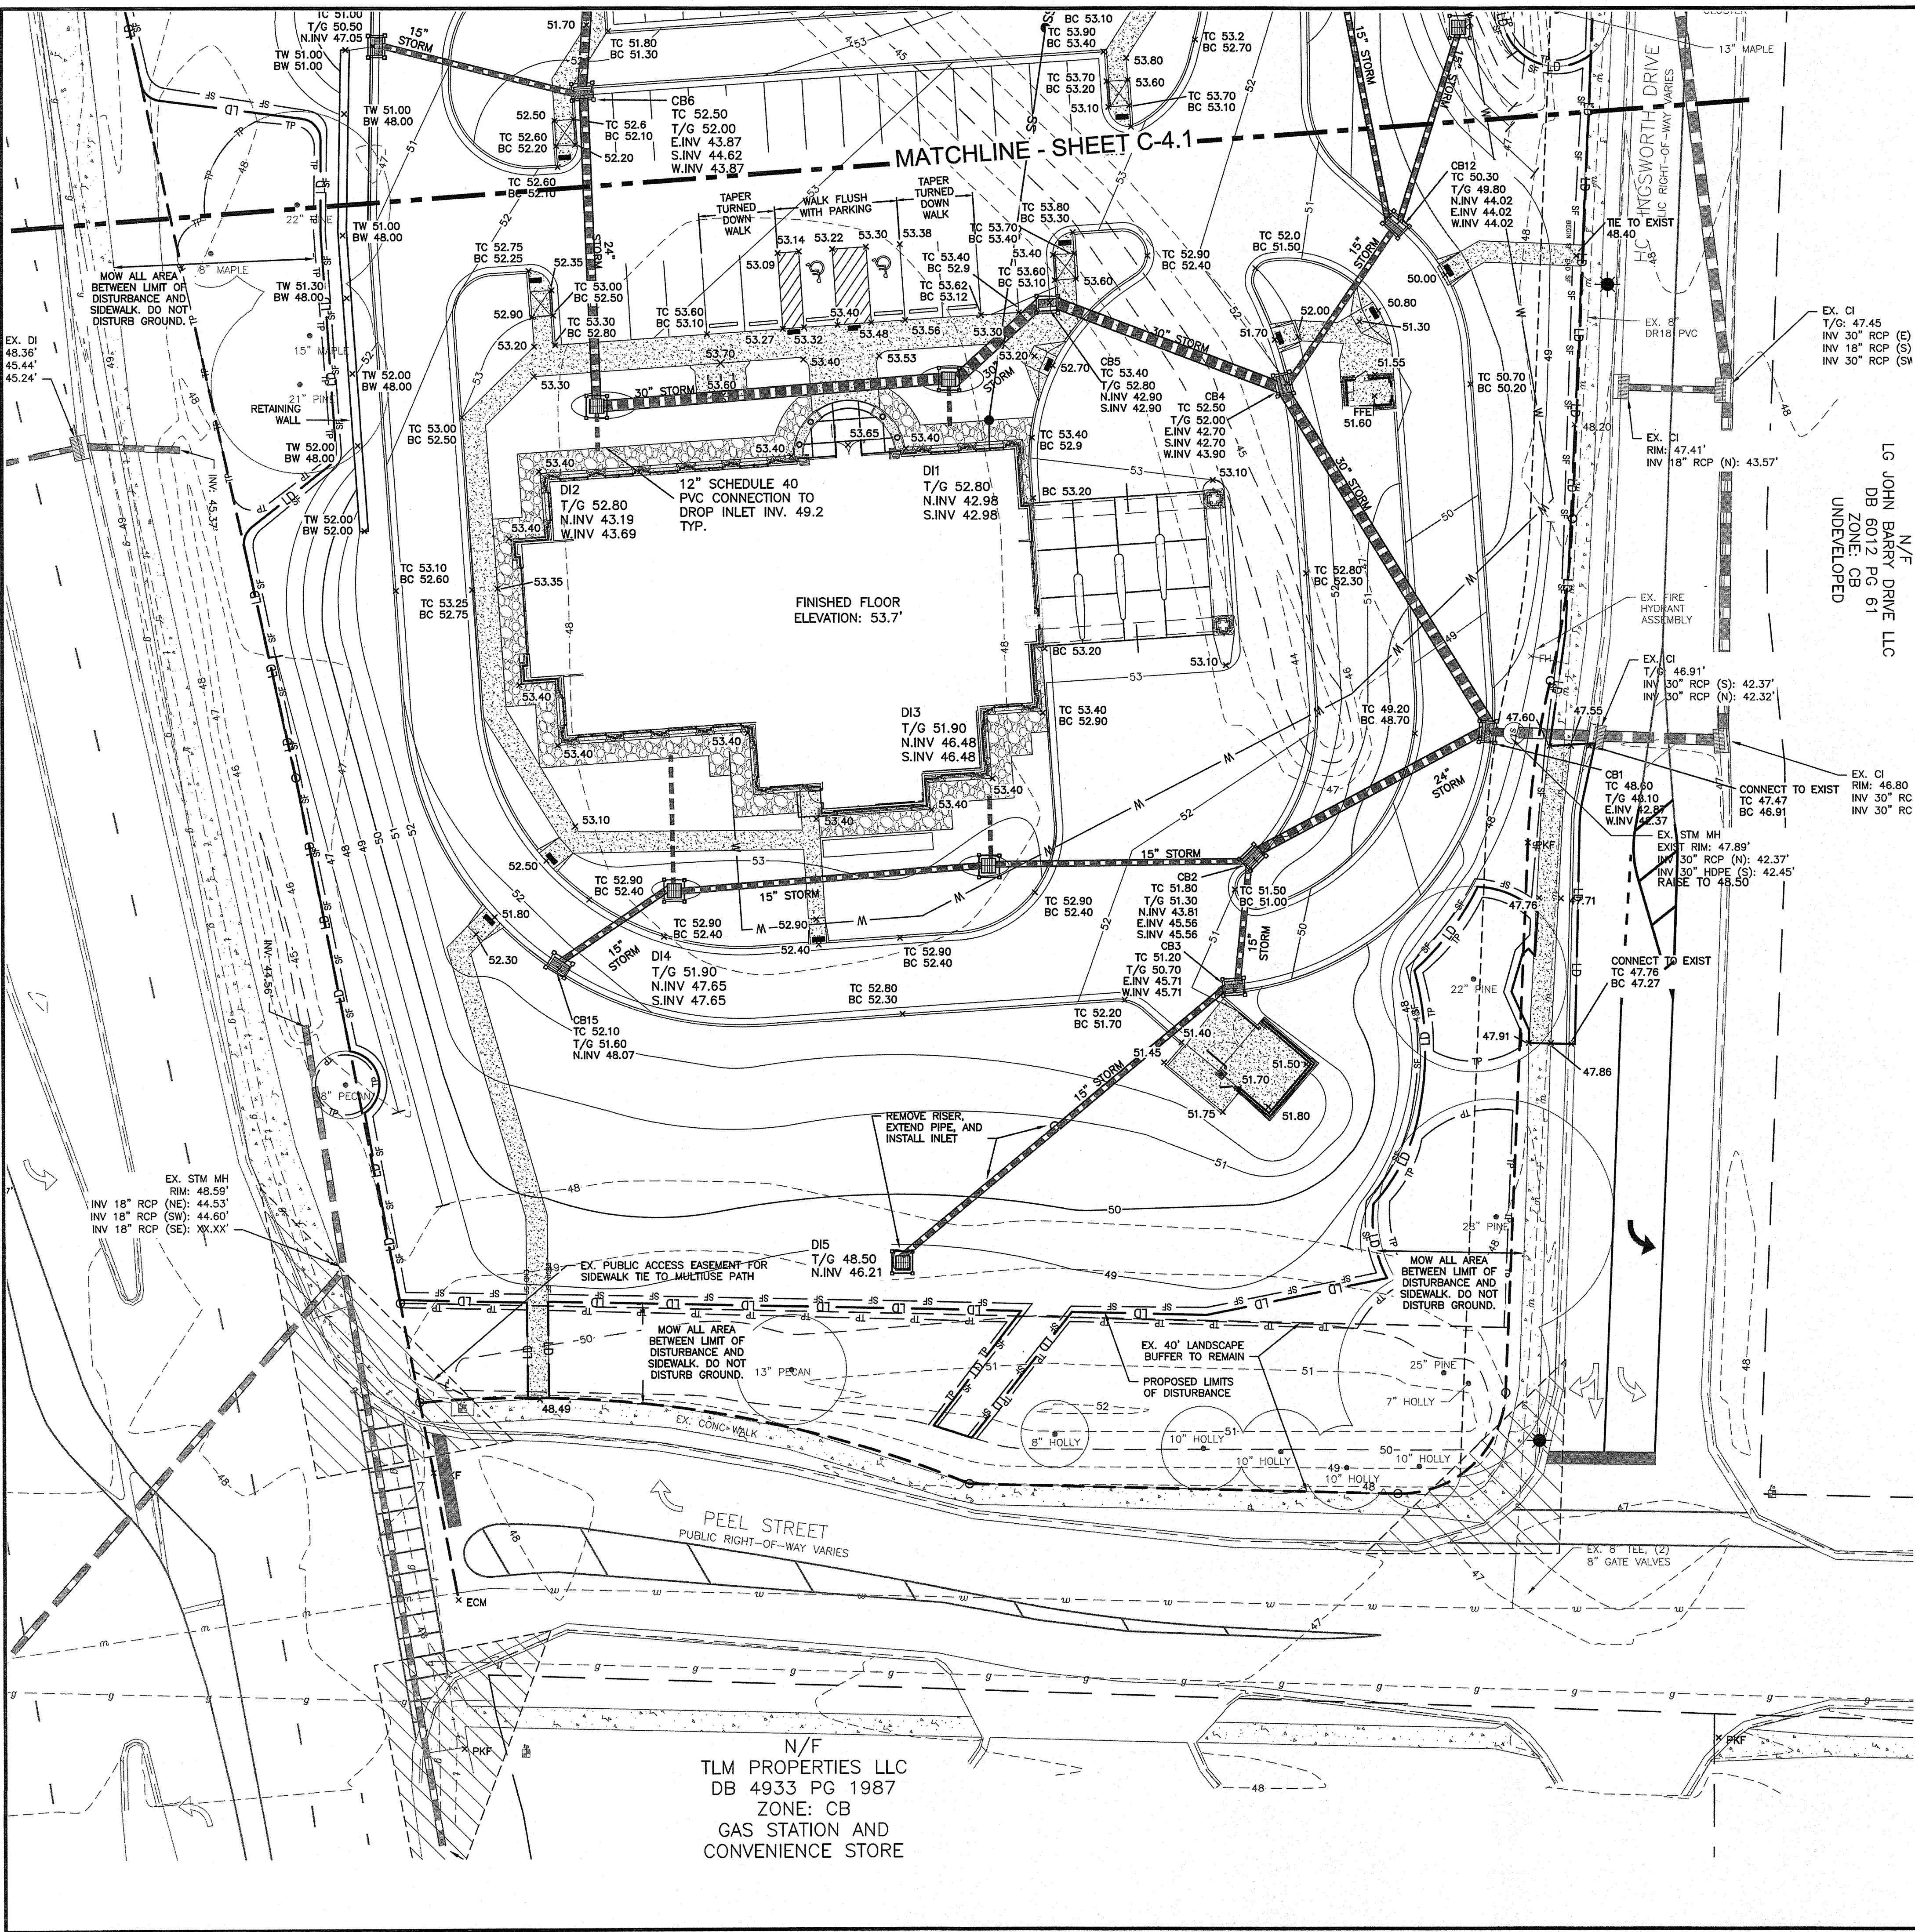


NO.	REVISION	DATE	BY	DESCRIPTION
1	REMAINING WALL PER CITY COMMENTS	12/16/2019		
2	PER CITY COMMENTS	12/16/2019		
3	USE PATIWAY CORRECTION	07/03/2020		

OWNER/DEVELOPER/APPLICANT
STATE EMPLOYEES' CREDIT UNION
ADDRESS:
119 N. SALISBURY STREET
RALEIGH, NORTH CAROLINA 27603
PHONE: 919-839-5300

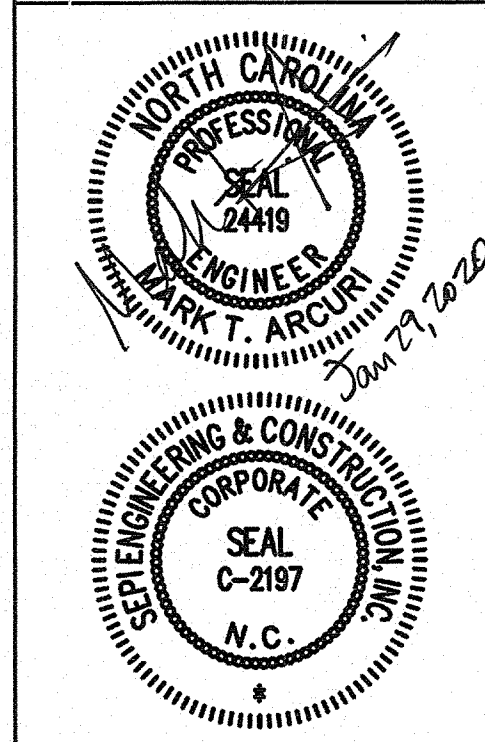PROJECT
STATE EMPLOYEES' CREDIT UNION - WILMINGTON S 17th STREET BRANCH
ADDRESS:
4355 S 17TH STREET
WILMINGTON NC 28412

PROJECT MANAGER
MTA
CHECKED BY:
DM
DRAWN BY:
KD
FIELD SURVEY DATE:
02/15/19
DRAWING DATE:
12/03/2019
JOB #:
SE18.19.100
SHEET
C-41



GRADING:

EXISTING MINOR CONTOUR	---	39
PROPOSED MINOR CONTOUR	---	39
EXISTING MAJOR CONTOUR	---	40
PROPOSED MAJOR CONTOUR	---	40
EXISTING SPOT ELEVATION	---	x 1.00
PROPOSED SPOT ELEVATION	---	x 1.00

EXISTING STORM PIPE	---
PROPOSED STORM PIPE	---
EXISTING DITCH AND FLOW DIRECTION	---
EXISTING STORM MANHOLE	---
PROPOSED STORM MANHOLE	---
PROPOSED CURB INLET	---
PROPOSED DROP INLET	---
T/G	TOP OF GRATE
BC	BACK OF CURB
TC	TOP OF CURB
CB	CATCH BASIN / CURB INLET
DI	DROP INLET
N./E./S./W. INV	NORTH, EAST, SOUTH, WEST INVERT

FILL EXISTING	+
INLET PROTECTION	---
PROPOSED SILT FENCE	SF
PROPOSED LIMITS OF DISTURBANCE	LD
PROPOSED TREE PROTECTION	TP


DISTURBED AREA
PROPOSED: 3.55 AC
PERCENTAGE: 154,750 SF
89%

ENGINEER NOTE
STORM DRAIN PIPE SHALL BE POLYPROPYLENE PIPE OR REINFORCED CONCRETE PIPE. IF RCP IT SHALL MEET CLASS 3 STANDARDS.

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1	RETAINING WALL PER CITY COMMENTS	12/16/2019
2	PER CITY COMMENTS	12/18/2019
3	USE PATHWAY CHANGED	01/03/2020

OWNER/DEVELOPER/APPLICANT:
STATE EMPLOYEES' CREDIT UNION
ADDRESS: 119 N. SALISBURY STREET
RALEIGH, NORTH CAROLINA 27603
PHONE: 919-839-5300

PROJECT:
STATE EMPLOYEES' CREDIT UNION - WILMINGTON S 17th STREET BRANCH
ADDRESS: 4355 S 17th STREET
WILMINGTON NC 28412

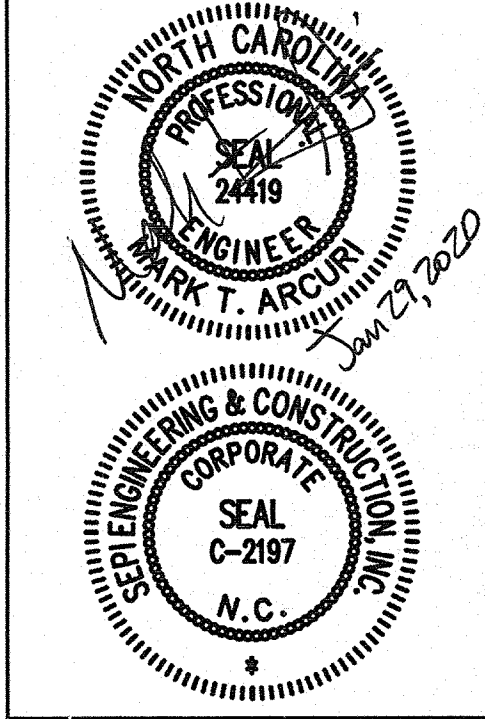PROJECT MANAGER	MTA	FIELD SURVEY DATE:	02/15/19
CHECKED BY:	DM	DRAWING DATE:	12/03/2019
DRAWN BY:	KD	JOB #	SE1819100
SHEET			

Approved Construction Plan

Name: Nicole Smith Date: 1/30/20


Traffic: W. Smith / 1-30-20

Fire: C. White / 1/30/20



CITY OF WILMINGTON
NORTH CAROLINA
Public Services • Engineering Division
APPROVED STORMWATER MANAGEMENT PLAN

Date: 1/30/2020 Permit # 202003


Signed: Keith Christian

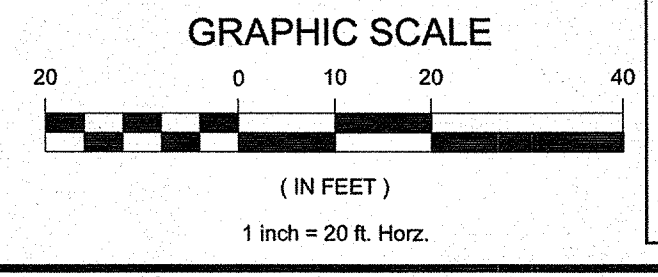

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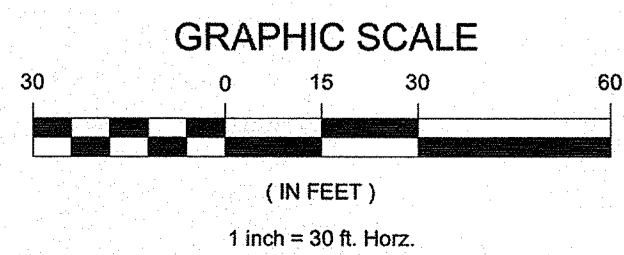


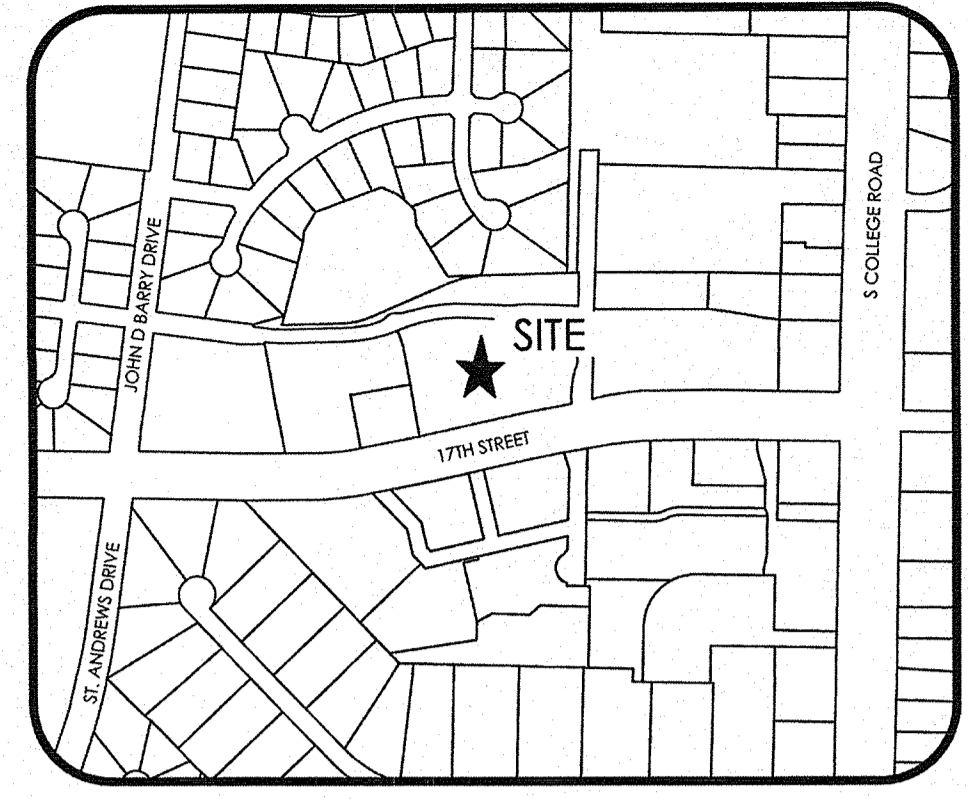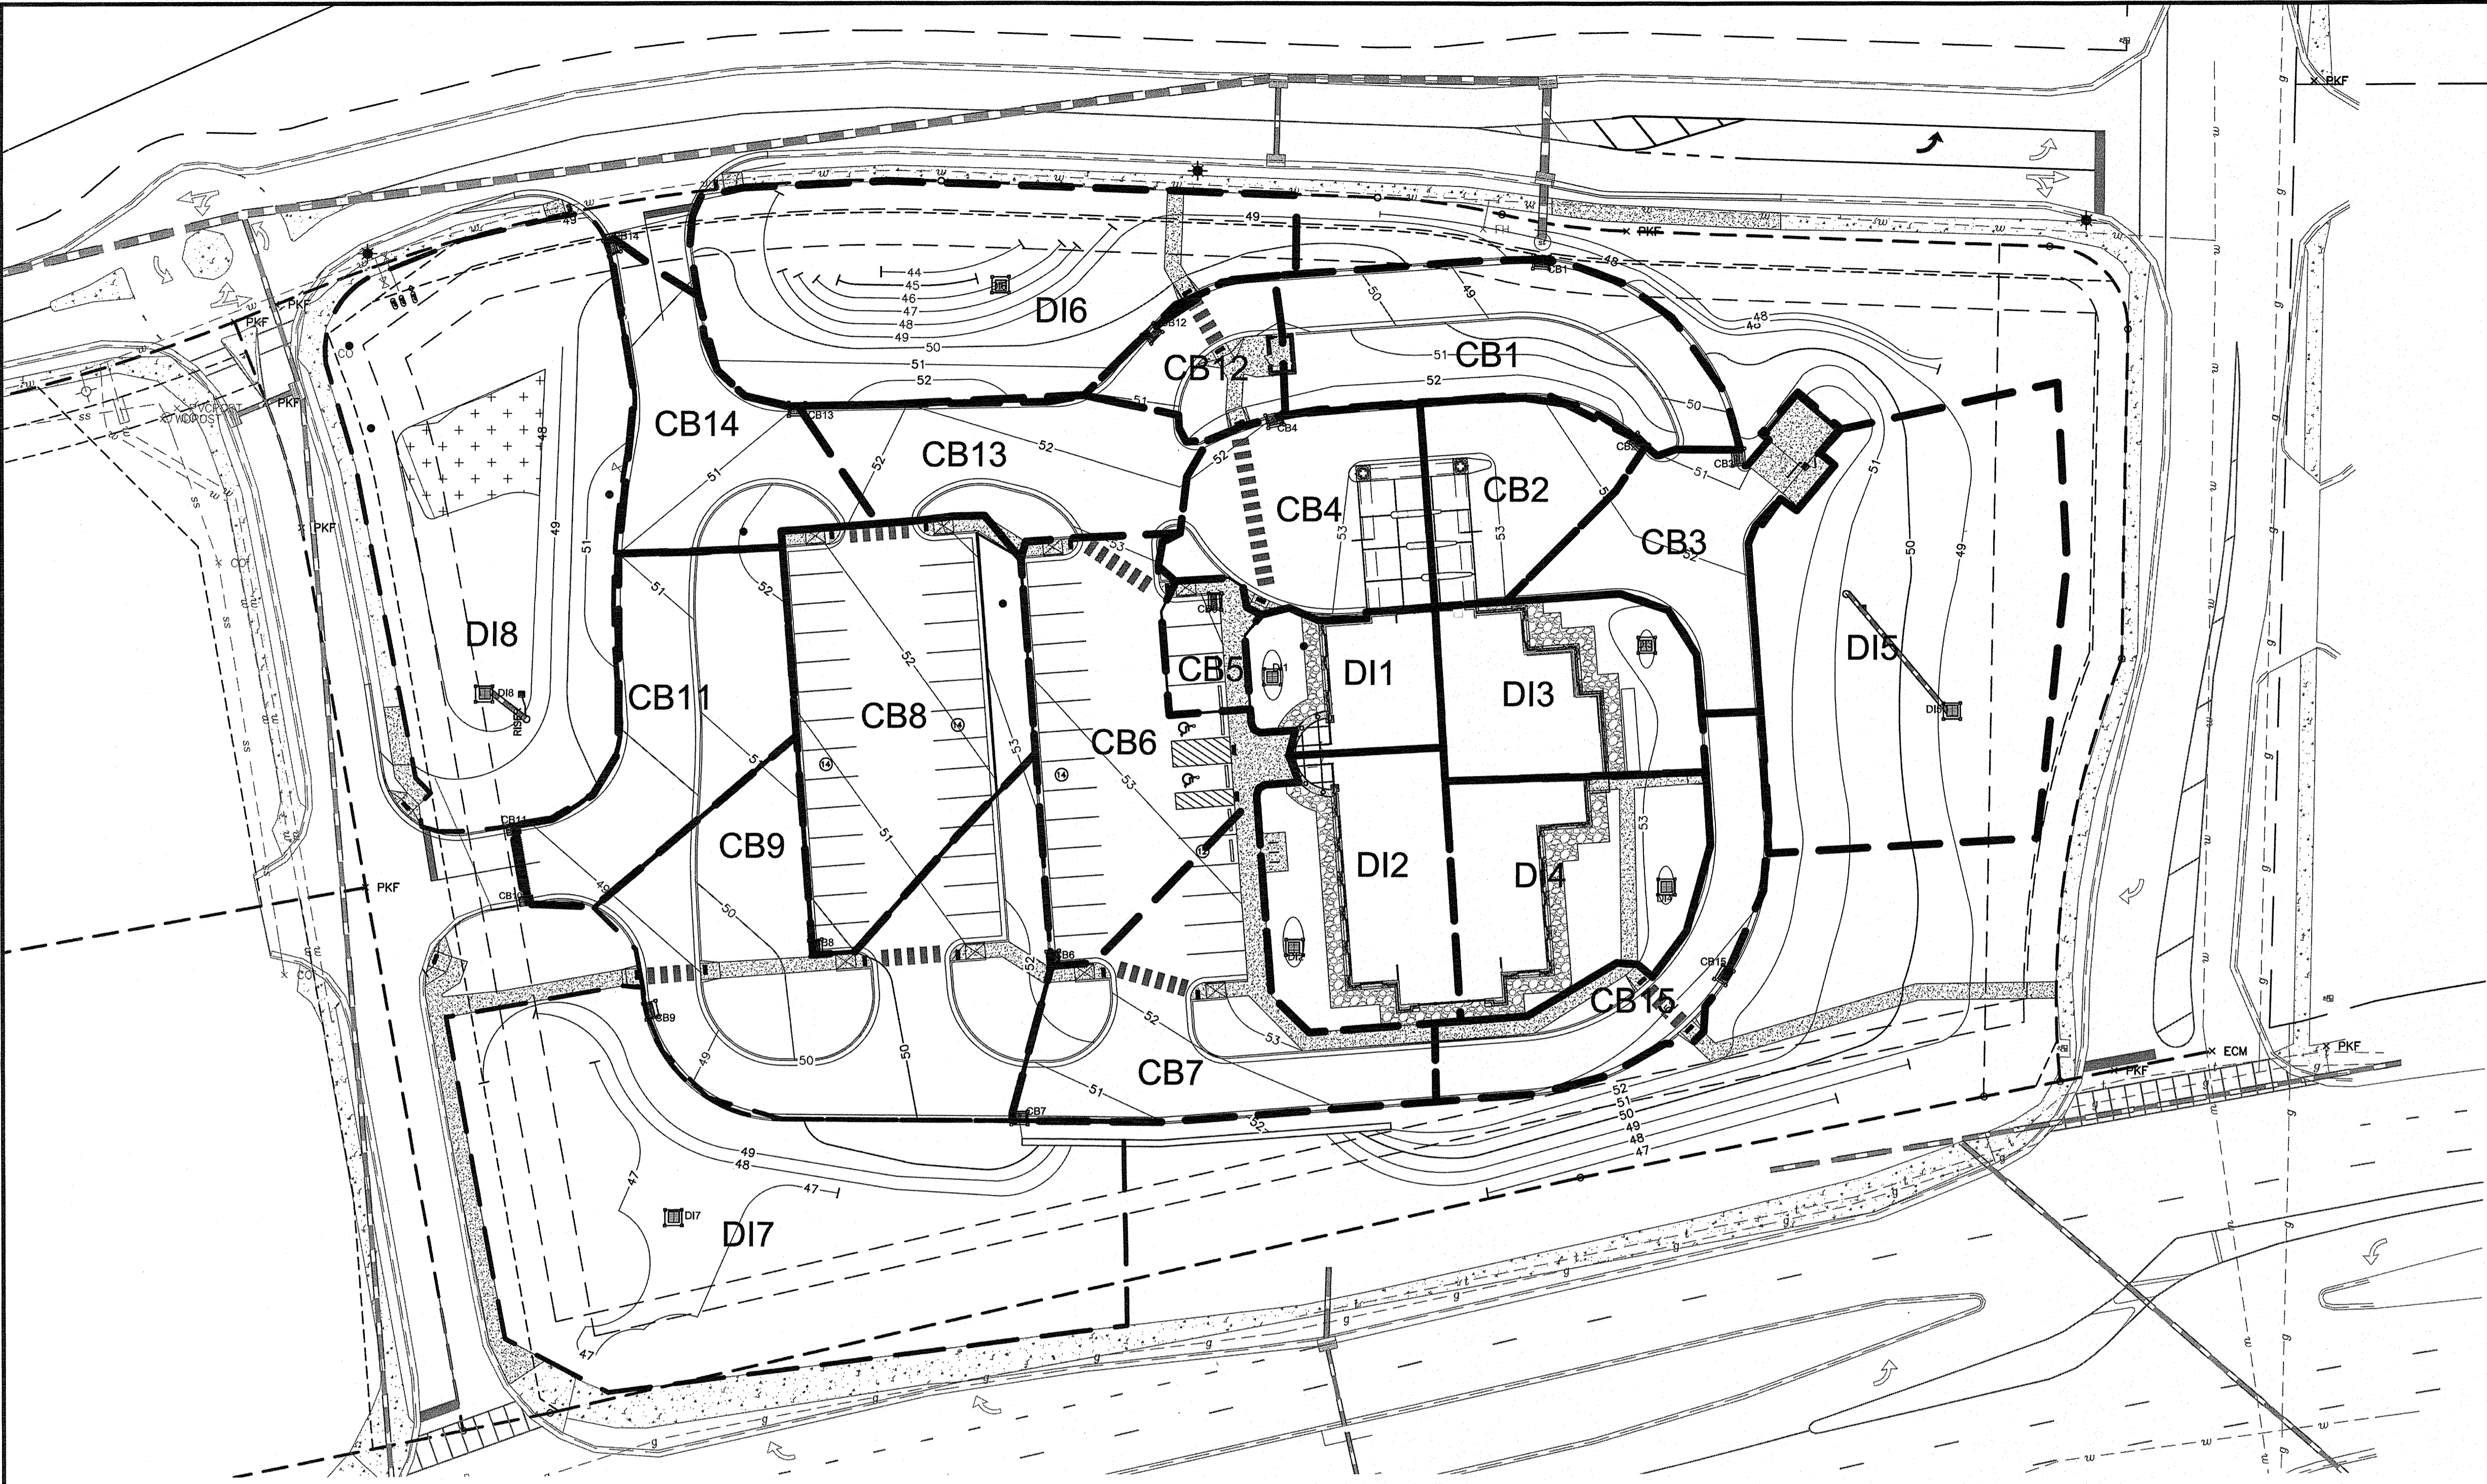VICINITY MAP
NOT TO SCALE

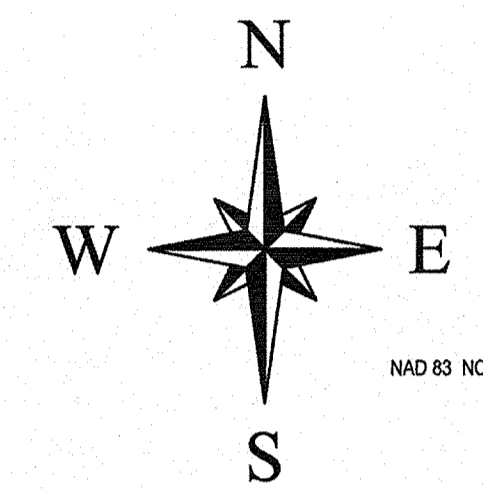

CB ——— CATCH BASIN / CURB INLET
DI ——— DROP INLET

Drainage Numbers	Impervious Area (SF)	Pervious Area (SF)	Total Area (SF)	Total Acres	Impervious C	Pervious C	Resultant C	Percent Impervious (%)
CB1	3009	2699	5708	0.13	0.95	0.17	0.58	53
CB2	3077	0	3077	0.07	0.95	0.17	0.95	100
CB3	3577	0	3577	0.08	0.95	0.17	0.95	100
CB4	4221	206	4427	0.10	0.95	0.17	0.91	95
CB5	996	32	1028	0.02	0.95	0.17	0.93	97
DI1	1615	792	2407	0.06	0.95	0.17	0.69	67
DI2	5489	1898	7387	0.17	0.95	0.17	0.75	74
CB6	6308	0	6308	0.14	0.95	0.17	0.95	100
CB7	5353	899	6252	0.14	0.95	0.17	0.84	86
CB8	6864	898	7762	0.18	0.95	0.17	0.86	86
CB9	6601	3615	10216	0.23	0.95	0.17	0.67	65
CB10	0	0	0	0.00	0.95	0.17	0.00	0
DI3	2274	1990	4264	0.10	0.95	0.17	0.59	53
DI4	2474	2518	4992	0.11	0.95	0.17	0.56	50
CB15	3551	143	3694	0.08	0.95	0.17	0.92	96
CB12	1437	461	1898	0.04	0.95	0.17	0.76	76
CB13	3584	439	4023	0.09	0.95	0.17	0.86	89
CB14	3630	547	4177	0.10	0.95	0.17	0.85	87
CB11	3032	2194	5226	0.12	0.95	0.17	0.62	58
DI5	0	11746	11746	0.27	0.95	0.17	0.17	0
DI6	0	10239	10239	0.24	0.95	0.17	0.17	0
DI7	0	17125	17125	0.39	0.95	0.17	0.17	0
DI8	0	13676	13676	0.31	0.95	0.17	0.17	0
Totals	67092	72017	139109	3.19	0.95	0.17	0.55	48



Approved Construction Plan
Name: *Nicole Demuth* Date: *1/30/20*
Planning: *Nicole Demuth*
Traffic: *W. Smith* 1-30-20
Fire: *C. Hill* 1/30/20

CITY OF WILMINGTON
NORTH CAROLINA
Public Services • Engineering Division
APPROVED STORMWATER MANAGEMENT PLAN
Date: *1/30/2020* permit # *2020003*
Signed: *Rich Christian*


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11020 DAVID TAYLOR DR., SUITE 115
CHARLOTTE, NC 28262
PHONE: 704.714.4850
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WILMINGTON, NC 28403
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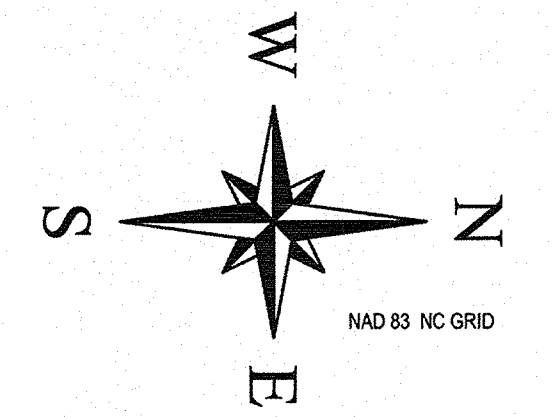
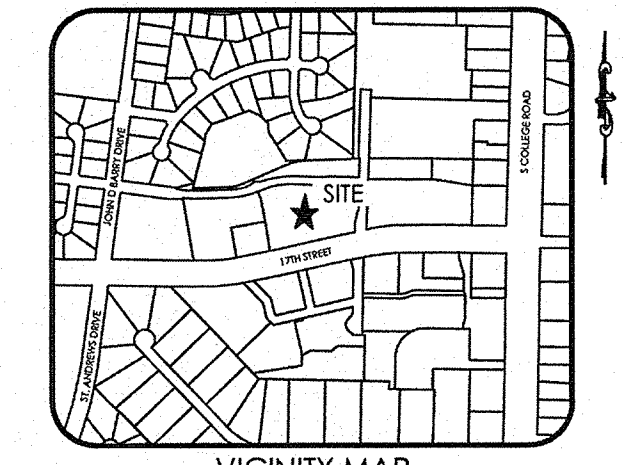
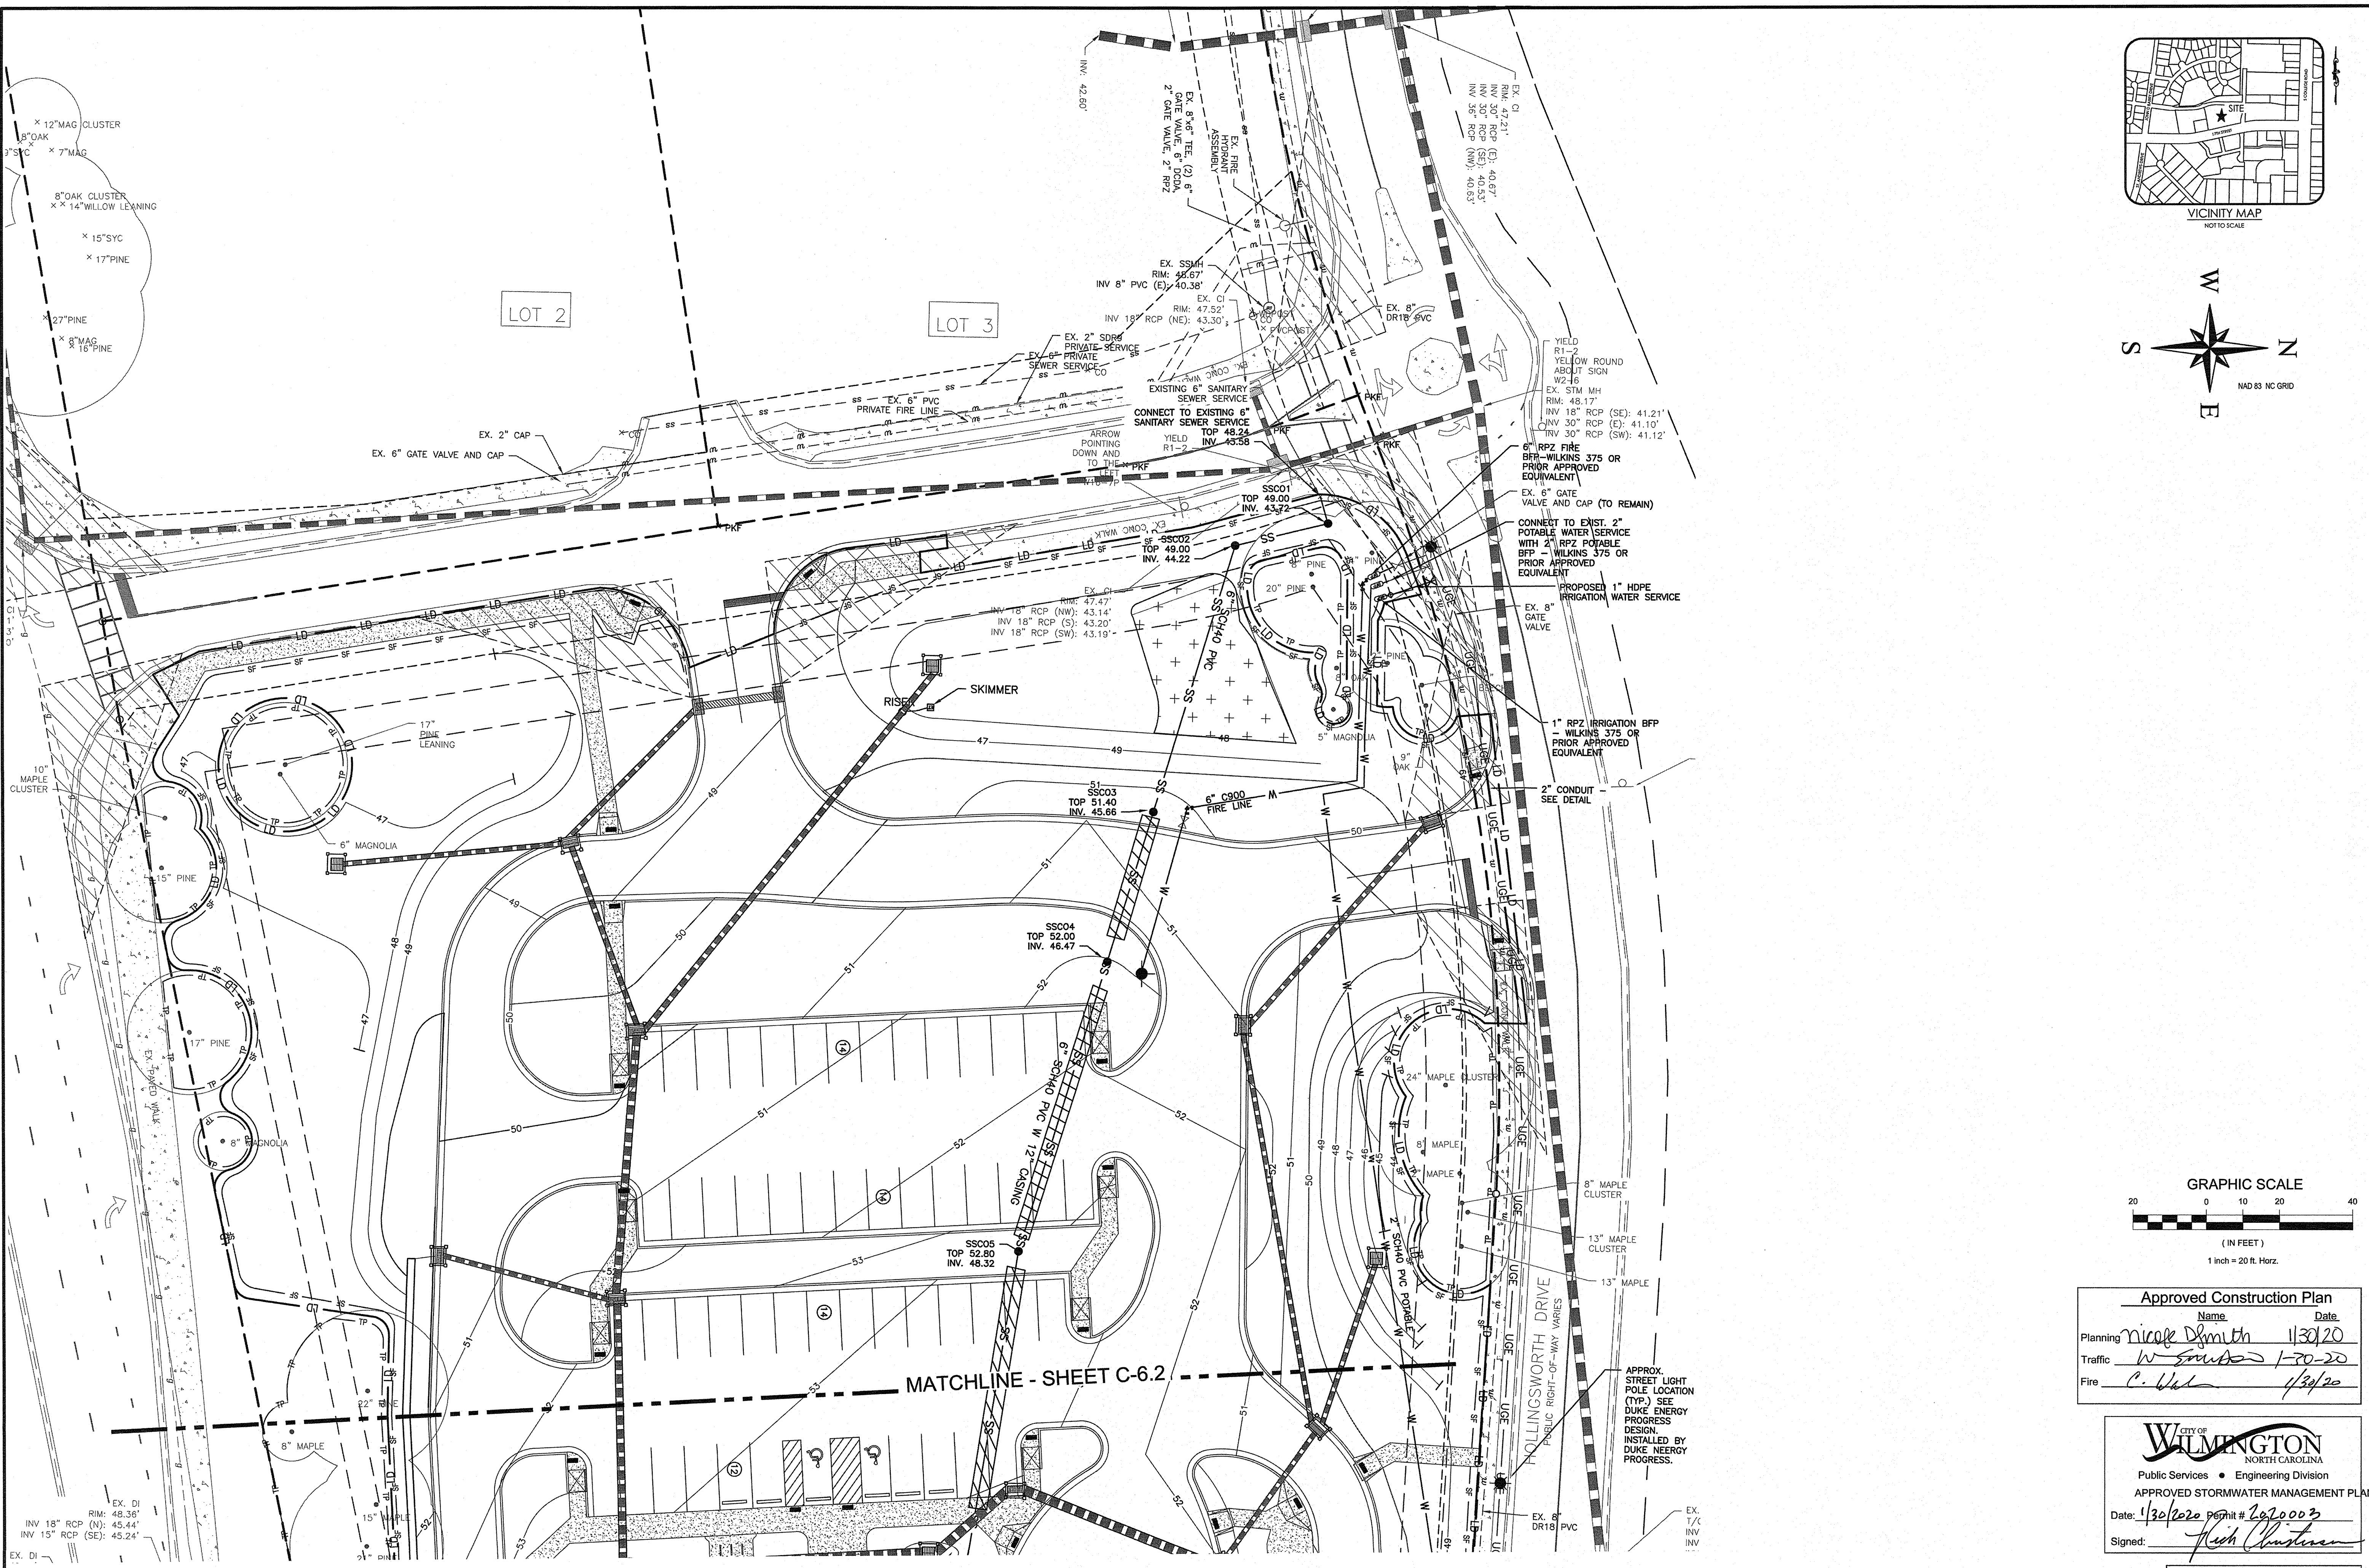
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OWNER/DEVELOPER/APPLICANT:
STATE EMPLOYEES' CREDIT UNION
ADDRESS: 119 N. SALISBURY STREET
RALEIGH, NORTH CAROLINA 27603
PHONE: 919-839-5300

PROJECT MANAGER:
STATE EMPLOYEES' CREDIT UNION - WILMINGTON S 17th STREET BRANCH
ADDRESS: 4355 S 17th STREET
WILMINGTON NC 28412

FIELD SURVEY DATE: *02/15/19*
CHECKED BY: *DM* DRAWING DATE: *12/03/2019*
DRAWN BY: *KD* JOB #: *SE1819100*
SHEET **C-51**





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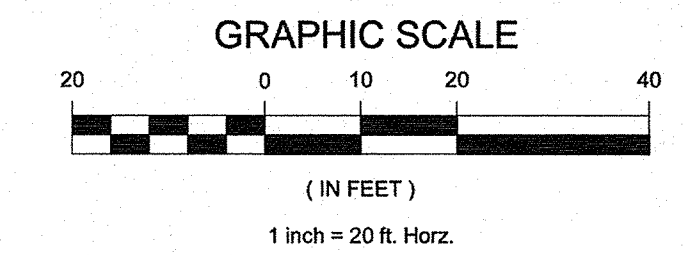
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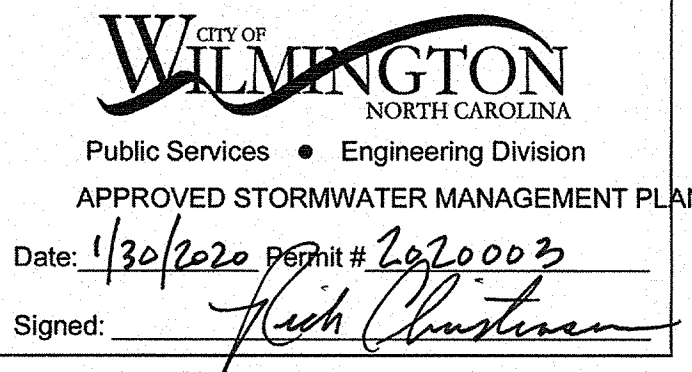
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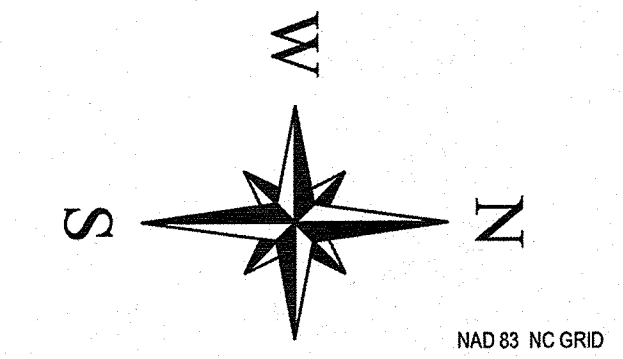
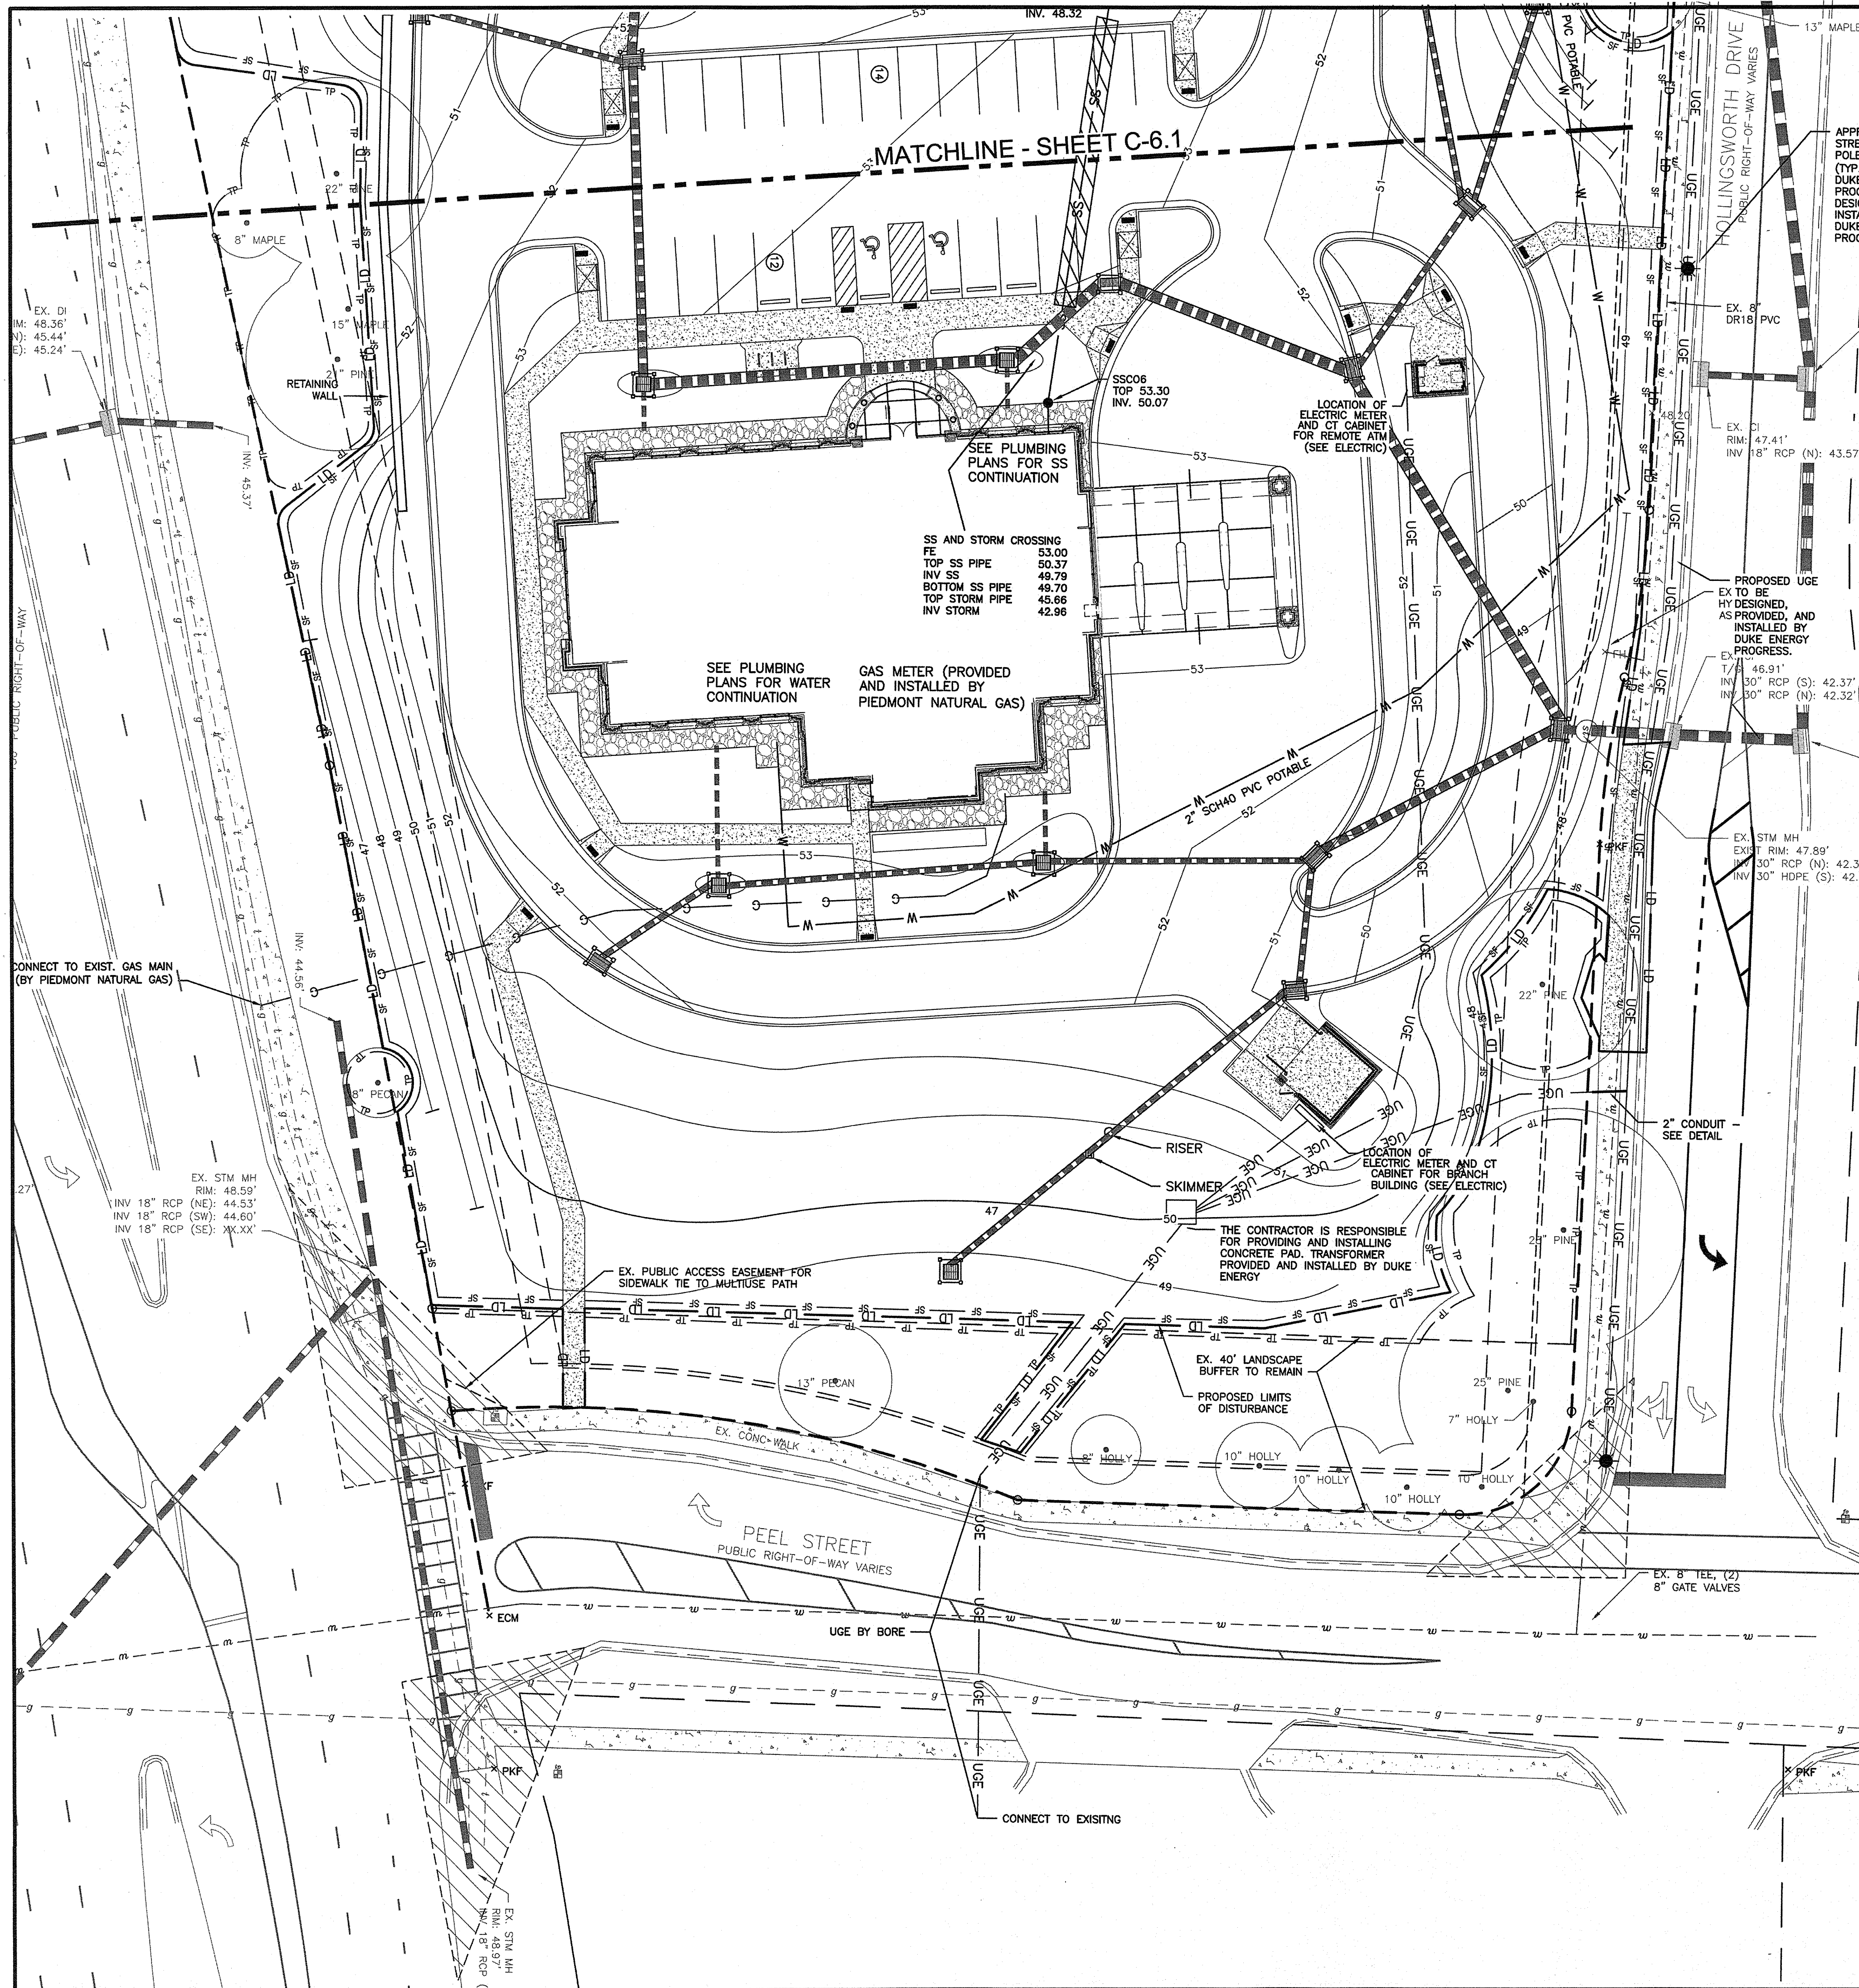


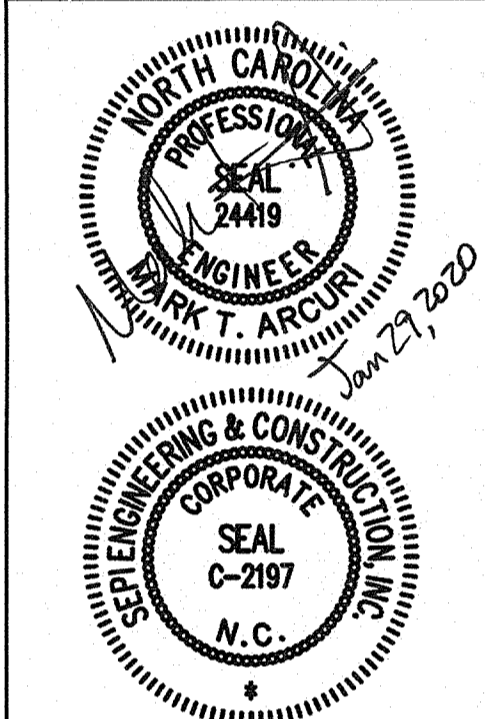Approved Construction Plan
Name: Nicole Smith Date: 11/30/20
Planning: W. S. Smith
Traffic: W. S. Smith
Fire: C. Wald



For each open utility cut of City streets, a \$325 permit shall be required from the City prior to occupancy and/or project acceptance

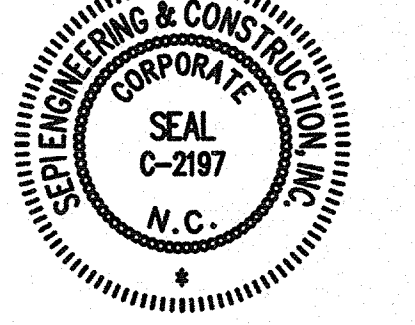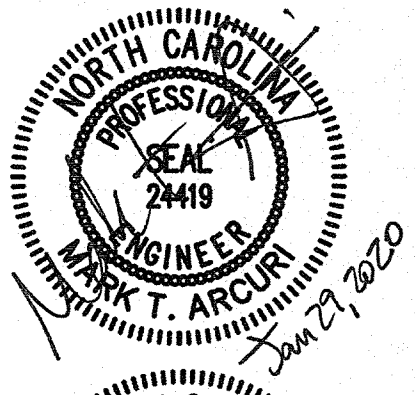OWNER/DEVELOPER/APPLICANT STATE EMPLOYEES' CREDIT UNION	ADDRESS: 119 N. SALISBURY STREET RALEIGH, NORTH CAROLINA 27603 PHONE: 919-839-5300	UTILITY PLAN
PROJECT STATE EMPLOYEES' CREDIT UNION - WILMINGTON S 17th STREET BRANCH	ADDRESS: 4355 S 17TH STREET WILMINGTON NC 28412	
PROJECT MANAGER MTA	FIELD SURVEY DATE: 02/16/19	SHEET C-6.1
CHECKED BY: DM	DRAWING DATE: 12/03/2019	
DRAWN BY: KD	JOB #: SE18.191.00	



SANITARY SEWER:		GAS:	
EXISTING FORCEMAIN	---	EXISTING GAS LINE	---
PROPOSED FORCEMAIN	---	PROPOSED GAS LINE	---
EXISTING GRAVITY SEWER	---	EXISTING GAS MARKER	○ 97M
PROPOSED GRAVITY SEWER	SS	PROPOSED GAS MARKER	● 97M
EXISTING SEWER MANHOLE	○ 60	EXISTING GAS METER	○ 97M
PROPOSED SEWER MANHOLE	○ 60	PROPOSED GAS METER	○ 97M
EXISTING CLEANOUT	○ 60	EXISTING GAS VALVE	○ 97M
PROPOSED CLEANOUT	○ 60	PROPOSED GAS VALVE	○ 97M
EXISTING SEWER VALVE	○ 60		
PROPOSED SEWER VALVE	○ 60		
EXISTING SEWER AIR RELEASE VALVE	○ 60		
PROPOSED SEWER AIR RELEASE VALVE	○ 60		
EXISTING FLOW METER	○ 60		
PROPOSED FLOW METER	○ 60		
WATER:		COMMUNICATIONS:	
EXISTING WATER LINE	---	EXISTING FIBER OPTIC	---
PROPOSED WATER LINE	---	PROPOSED FIBER OPTIC	FO FO
EXISTING WATER REUSE LINE	---	EXISTING OVERHEAD TELEPHONE	---
PROPOSED WATER REUSE LINE	---	PROPOSED OVERHEAD TELEPHONE	OHT
EXISTING WATER VALVE	---	EXISTING UNDERGROUND TELEPHONE	---
PROPOSED WATER VALVE	---	PROPOSED UNDERGROUND TELEPHONE	T
EXISTING WATER METER	---	EXISTING OVERHEAD CABLE	---
PROPOSED WATER METER	---	PROPOSED OVERHEAD CABLE	OHC
EXISTING FIRE HYDRANT	---	EXISTING UNDERGROUND CABLE	---
PROPOSED FIRE HYDRANT	---	EXISTING TELEPHONE PEDESTAL	---
EXISTING IRRIGATION CONTROL VALVE	---	PROPOSED TELEPHONE PEDESTAL	---
PROPOSED IRRIGATION CONTROL VALVE	---	EXISTING CABLE BOX	---
EXISTING SPRINKLER HEAD	---	PROPOSED CABLE BOX	---
PROPOSED SPRINKLER HEAD	---	EXISTING FIBER OPTIC MARKER	---
EXISTING BACKFLOW PREVENTER	---	PROPOSED FIBER OPTIC MARKER	---
PROPOSED BACKFLOW PREVENTER	---	EXISTING TELEPHONE MANHOLE	---
EXISTING HOSE BIBB	---	EXISTING FIBER OPTIC PEDESTAL	---
PROPOSED HOSE BIBB	---	PROPOSED FIBER OPTIC PEDESTAL	---
EXISTING YARD HYDRANT	---		
PROPOSED YARD HYDRANT	---		
EXISTING FIRE DEPARTMENT CONNECTION	---		
PROPOSED FIRE DEPARTMENT CONNECTION	---		
EXISTING FIRE DEPARTMENT CONNECTION VALVE	---		
PROPOSED FIRE DEPARTMENT CONNECTION VALVE	---		
ELECTRIC:			
EXISTING UNDERGROUND ELECTRIC	---		
PROPOSED UNDERGROUND ELECTRIC	---		
EXISTING OVERHEAD ELECTRIC	---		
PROPOSED OVERHEAD ELECTRIC	---		
EXISTING POWER POLE	---		
PROPOSED POWER POLE	---		
EXISTING GUY POLE	---		
PROPOSED GUY POLE	---		
EXISTING GUY WIRE	---		
PROPOSED GUY WIRE	---		
EXISTING LIGHT POLE	---		
EXISTING LIGHT POLE, RECOATED	---		
PROPOSED LIGHT POLE	---		
EXISTING TRANSFORMER	---		
PROPOSED TRANSFORMER	---		
EXISTING ELECTRIC METER	---		
PROPOSED ELECTRIC METER	---		


Approved Construction Plan

Name: *Wade Smith* Date: *1/30/20*

Planning: *Wade Smith* Traffic: *Wade Smith* Fire: *C. Wald*

CITY OF WILMINGTON
NORTH CAROLINA
Public Services • Engineering Division
APPROVED STORMWATER MANAGEMENT PLAN

Date: *1/30/20* Permit # *2020003*
Signed: *Josh Christian*

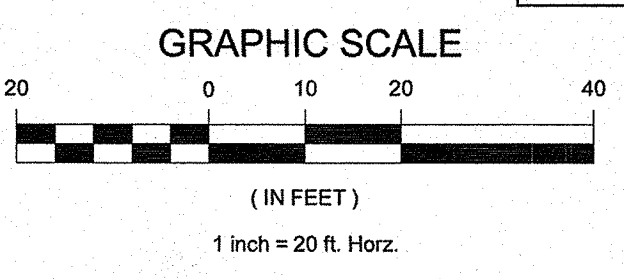


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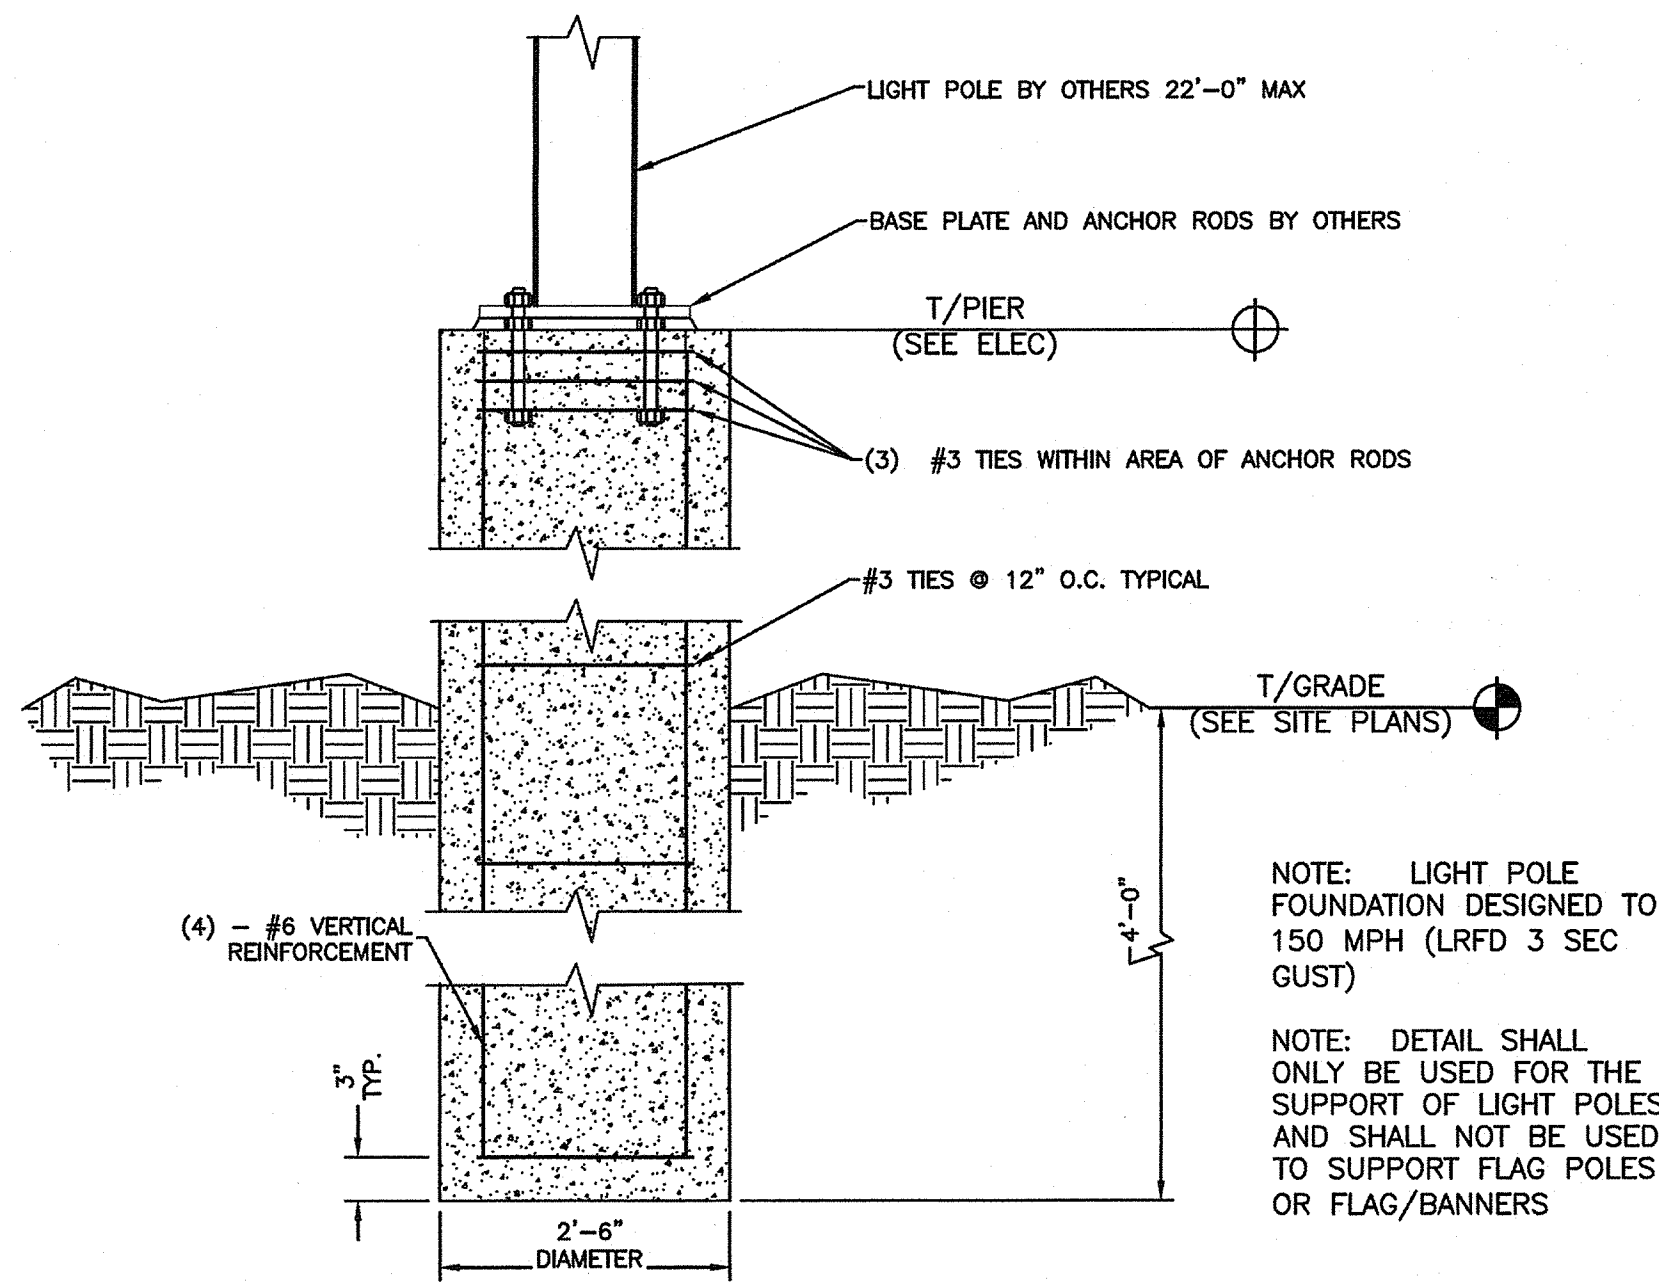
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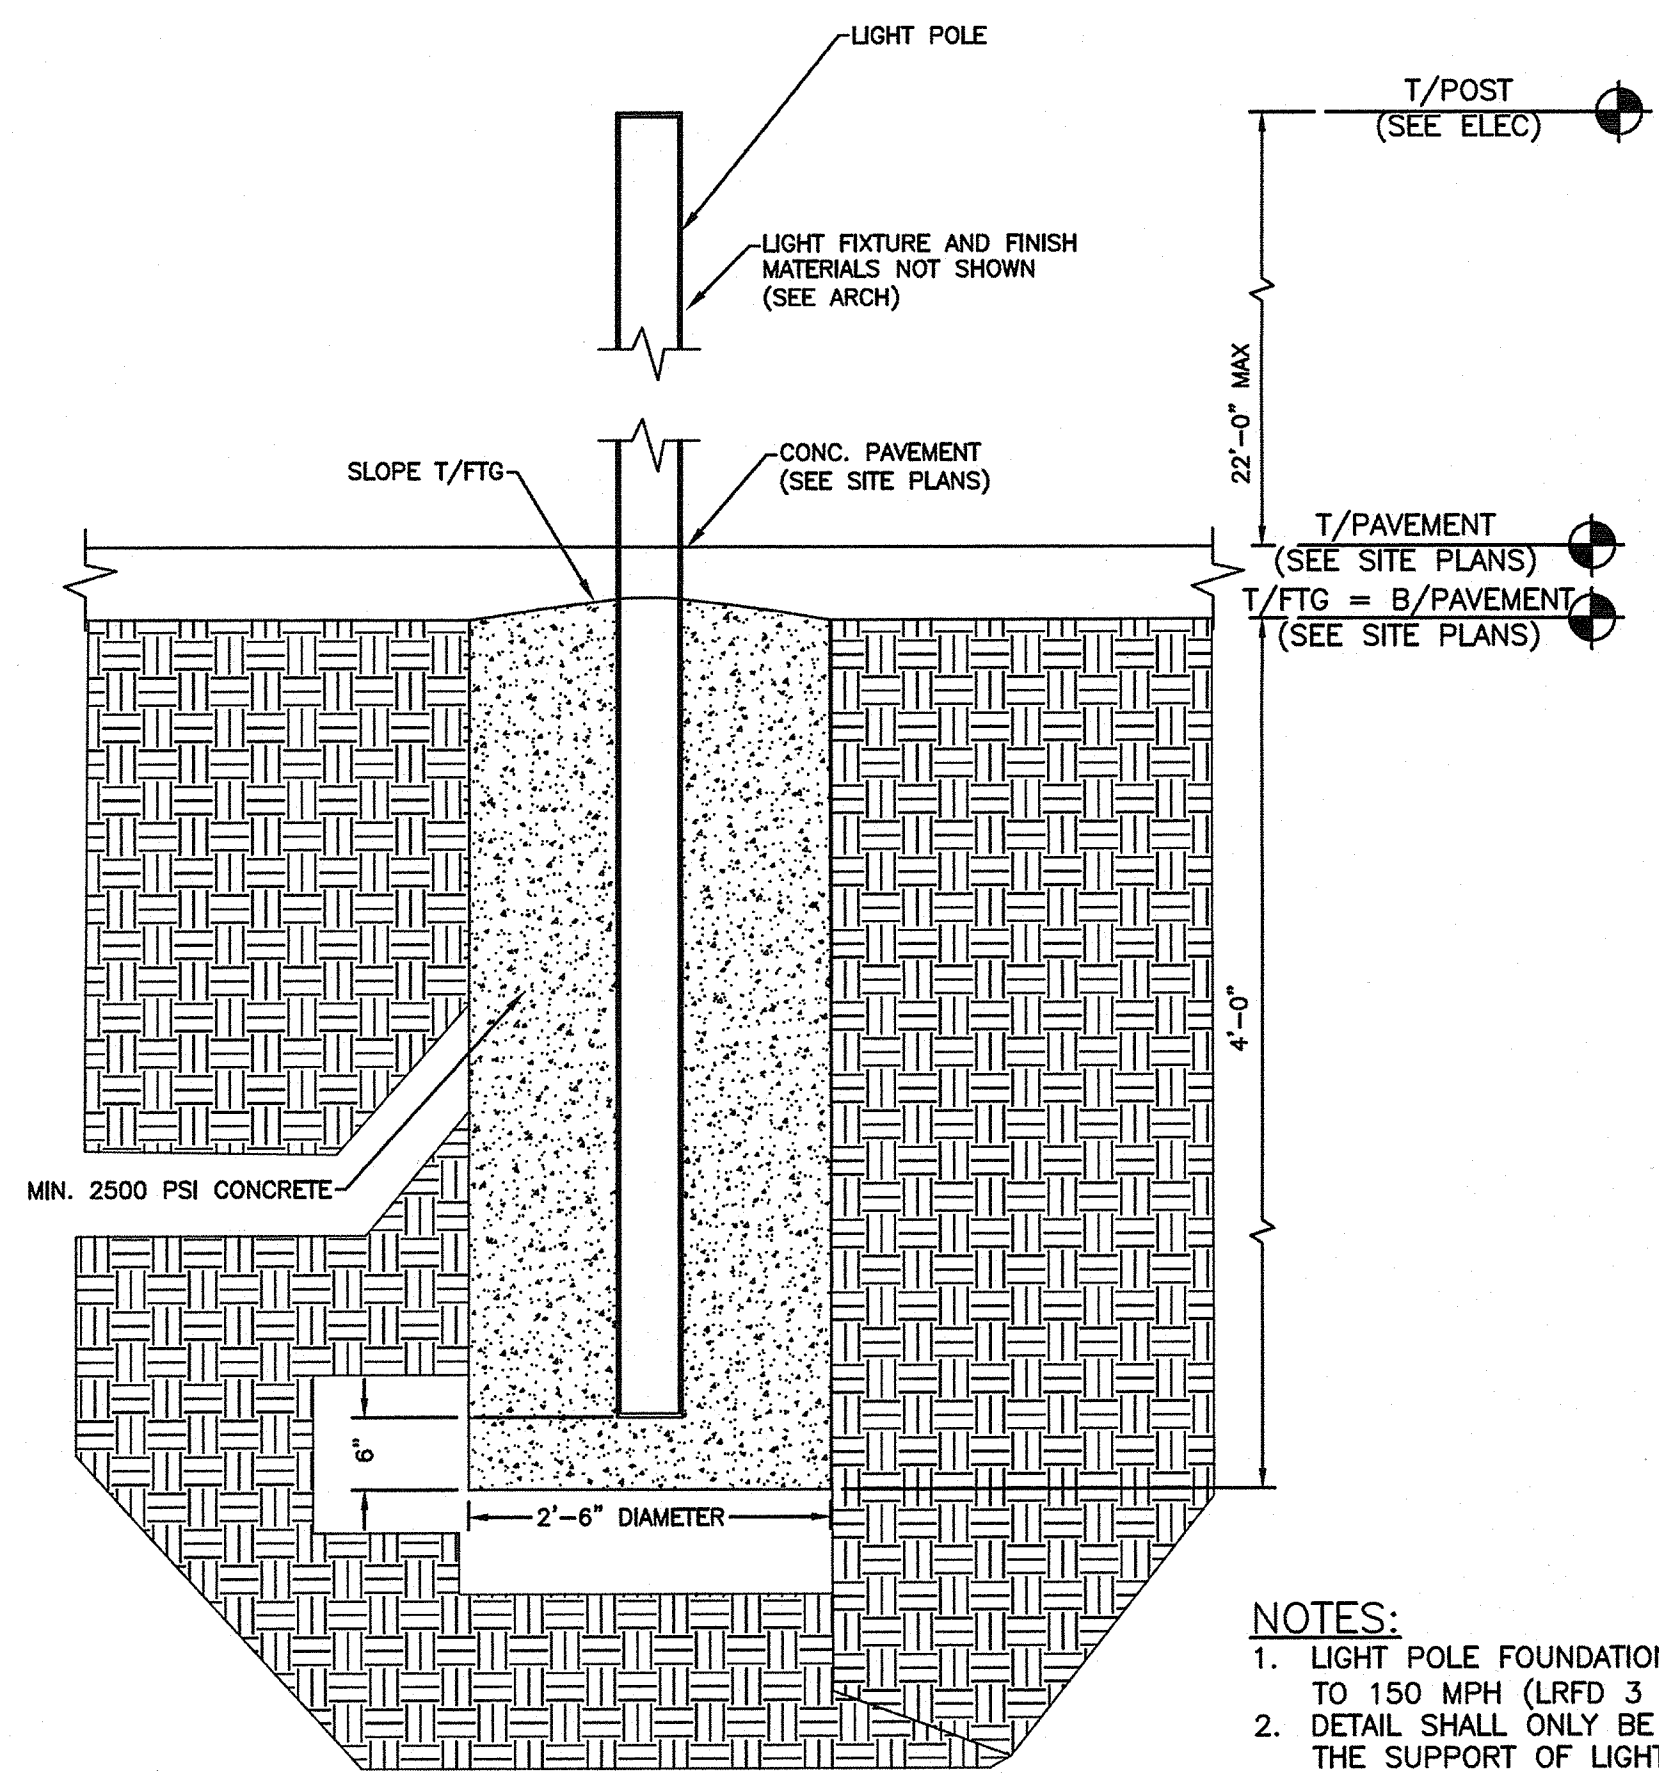


OWNER/DEVELOPER/APPLICANT	STATE EMPLOYEES' CREDIT UNION	ADDRESS: 119 N. SALISBURY STREET RALEIGH, NORTH CAROLINA 27603 PHONE: 919-839-5300
PROJECT	STATE EMPLOYEES' CREDIT UNION - WILMINGTON S 17TH STREET BRANCH	ADDRESS: 4355 S. 17TH STREET WILMINGTON NC 28412
PROJECT MANAGER	MTA	FIELD SURVEY DATE: 02/15/19
CHECKED BY:	DM	DRAWING DATE: 12/03/2019
DRAWN BY:	KD	JOB #: SE1819100
SHEET		C-6.2

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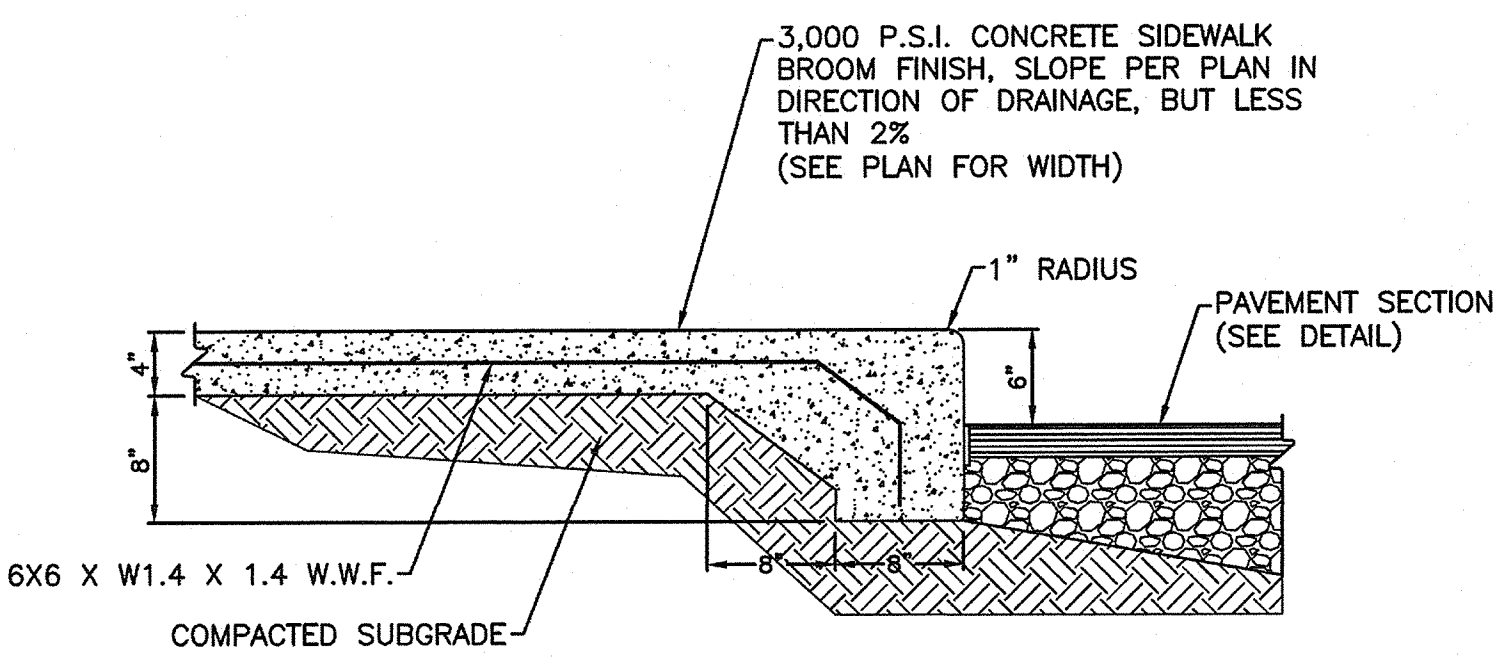


TYPICAL LIGHT POLE FOUNDATION (ALT A)
NOT TO SCALE

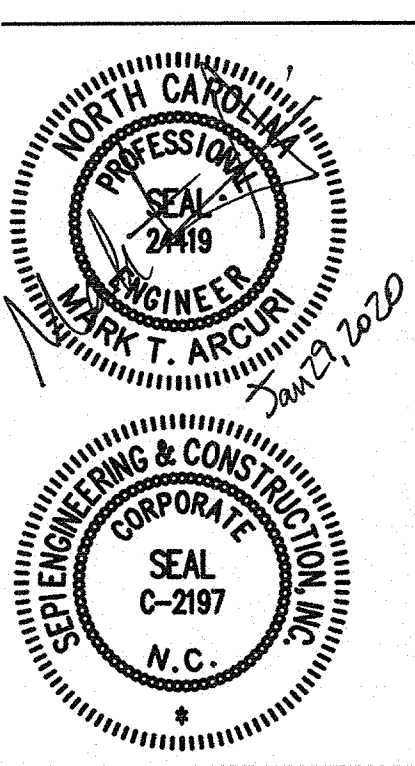


TYPICAL LIGHT POLE FOUNDATION (ALT B)
NOT TO SCALE

- NOTES:**
1. LIGHT POLE FOUNDATION DESIGNED TO 150 MPH (LRFD 3 SEC GUST) DETAIL SHALL ONLY BE USED FOR THE SUPPORT OF LIGHT POLES AND SHALL NOT BE USED TO SUPPORT FLAG POLES OR FLAG/BANNERS
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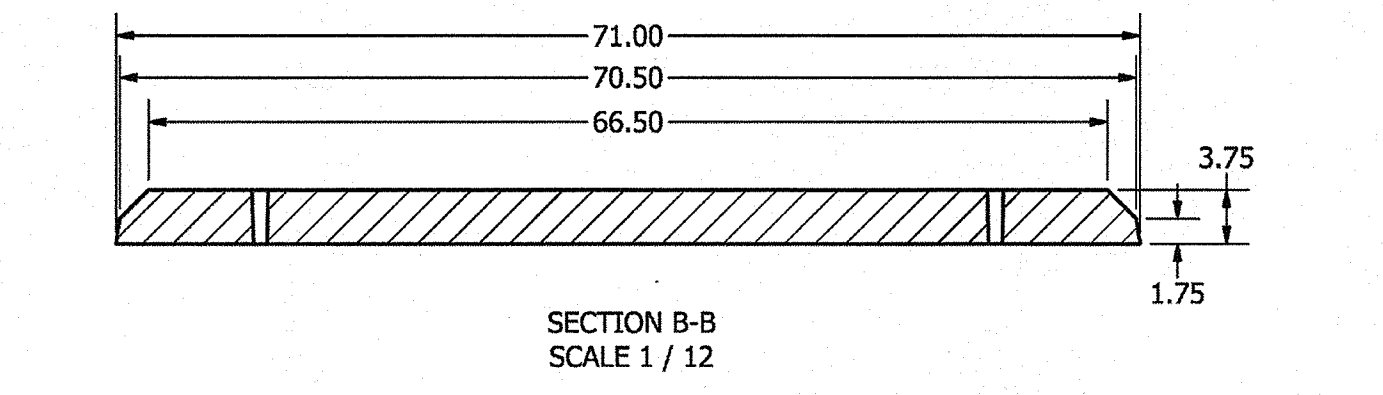
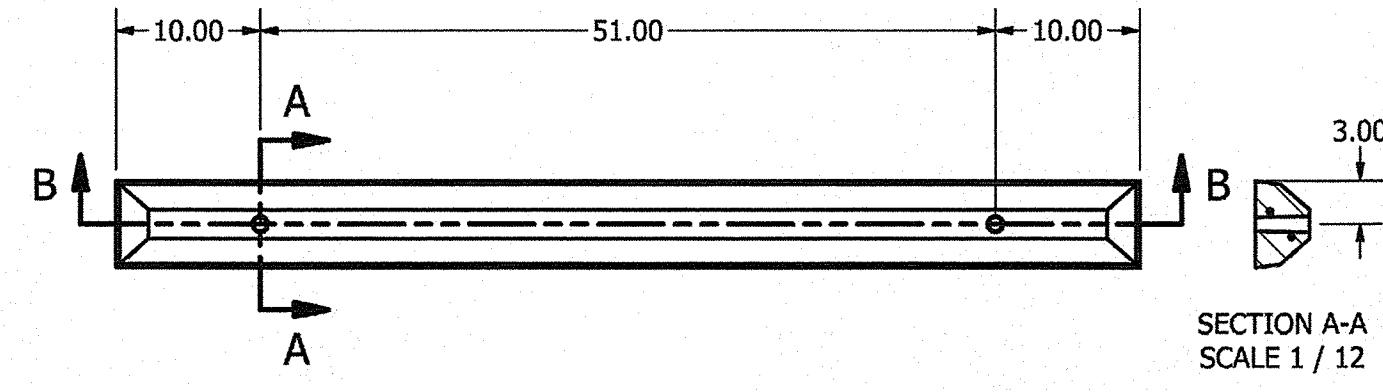
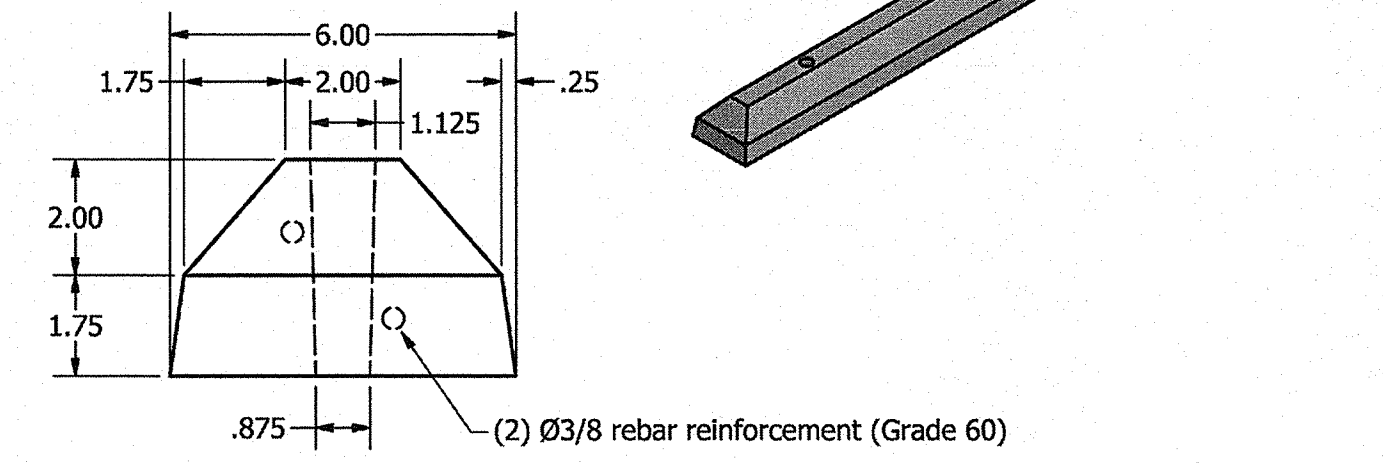


TURN-DOWN SIDEWALK DETAIL
NOT TO SCALE

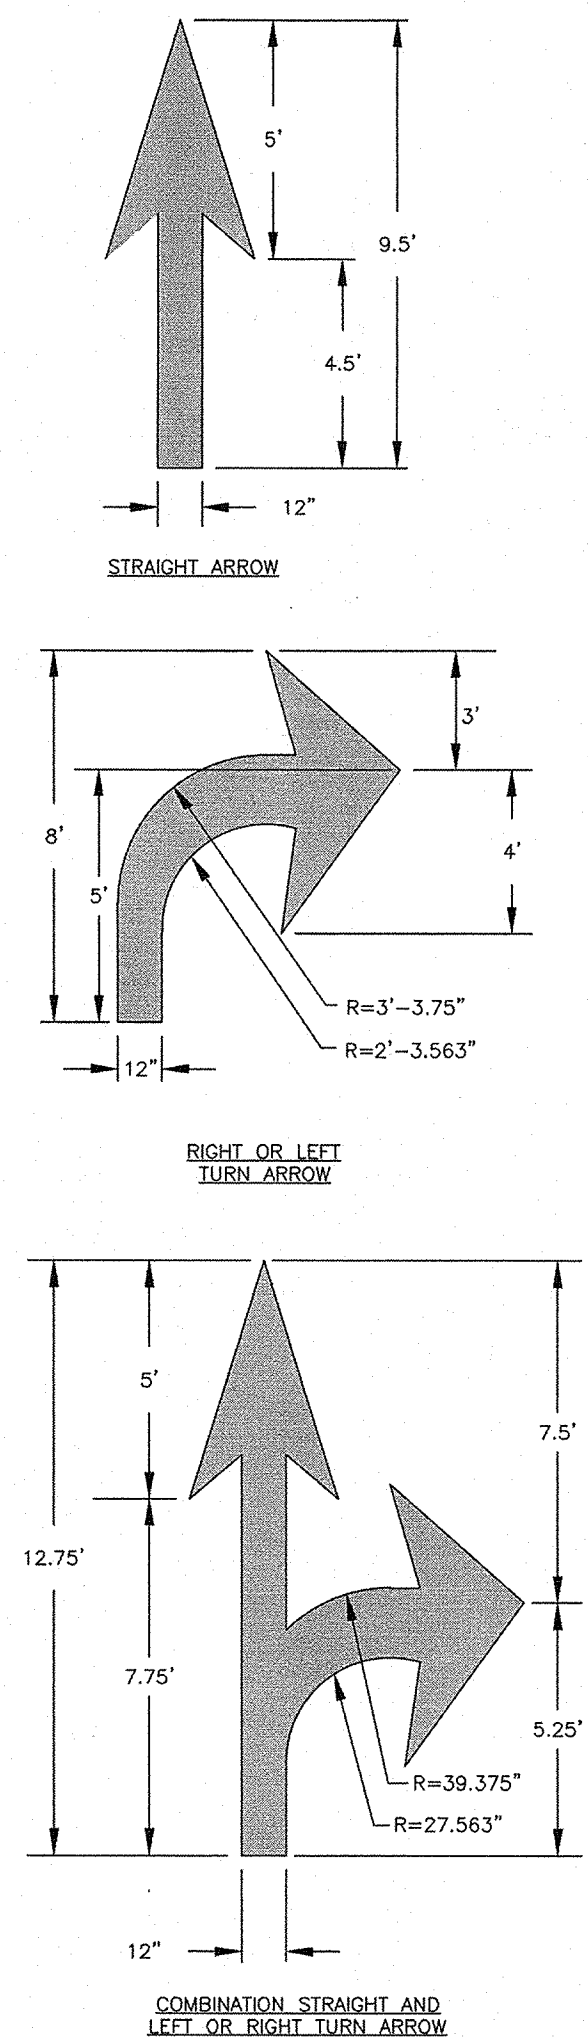


Mini Parking Bumper 71"


Item no. 5000m
Wt. 104 lb




WHEEL STOP DETAIL
NOT TO SCALE

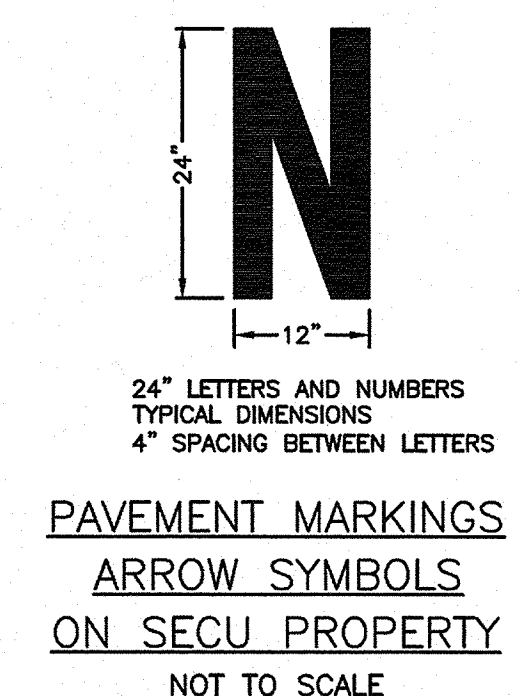

**PAVEMENT MARKINGS
ARROW SYMBOLS
ON SECU PROPERTY**
NOT TO SCALE

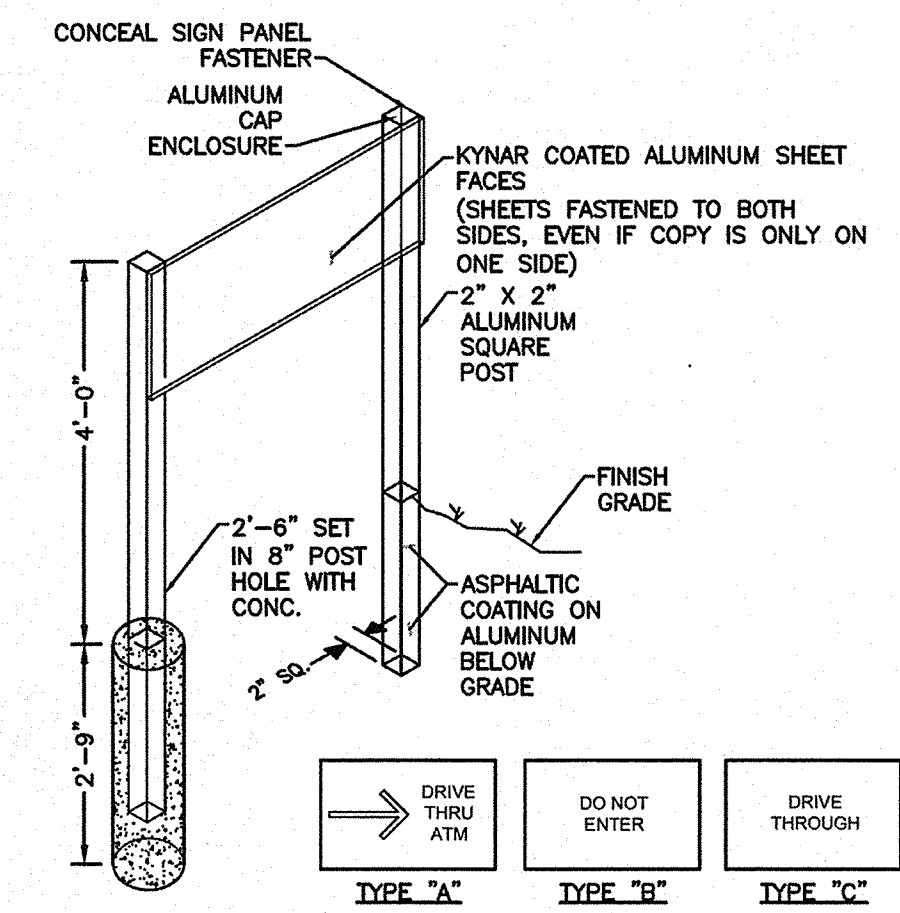


DIRECTIONAL SIGN DETAIL
NOT TO SCALE

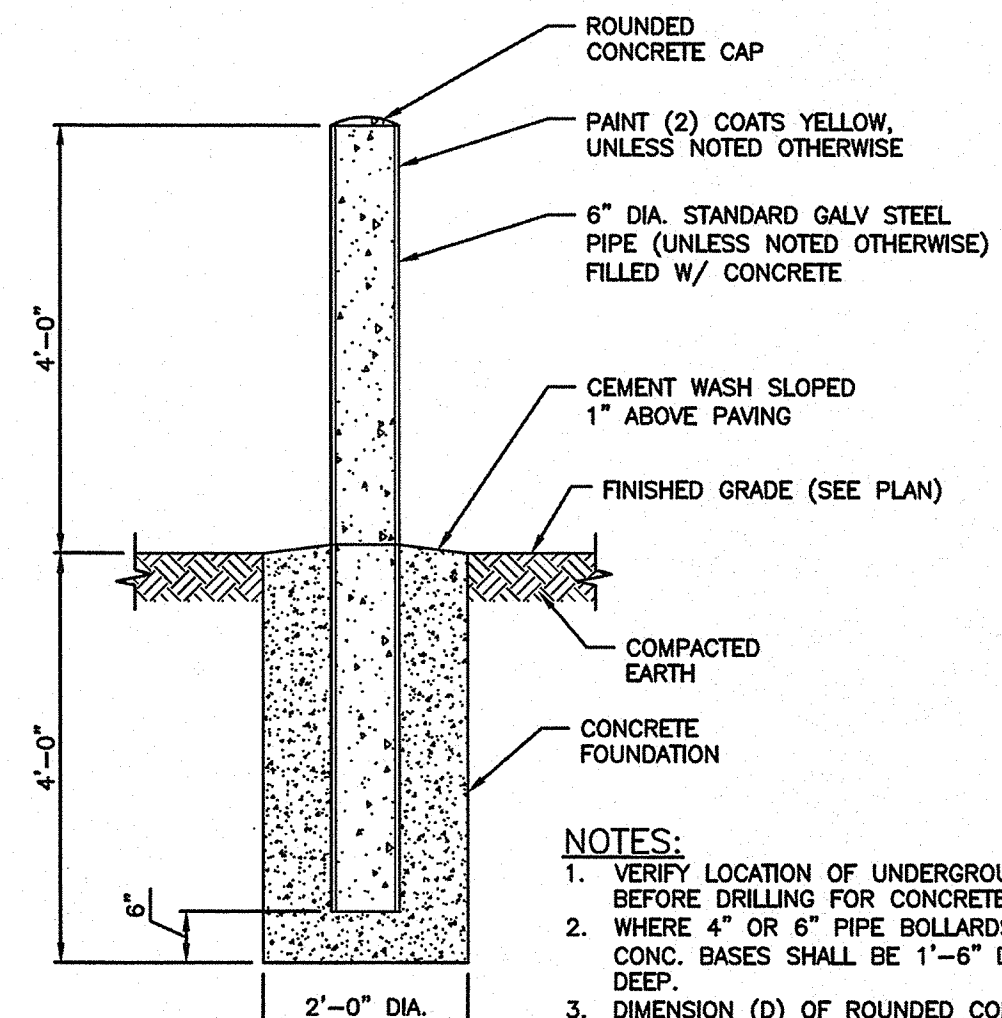


EXTERIOR PIPE BOLLARD
NOT TO SCALE

- NOTES:**
1. VERIFY LOCATION OF UNDERGROUND UTILITIES BEFORE DRILLING FOR CONCRETE FOUNDATION.
 2. WHERE 4" OR 6" PIPE BOLLARDS ARE SPECIFIED, CONC. BASES SHALL BE 1'-6" DIA. BY 3'-0" DEEP.
 3. DIMENSION (D) OF ROUNDED CONCRETE CAP SHALL BE 1/4 PIPE DIAMETER.
 4. PAINT "BROWN" WHEN LOCATED IN PLANTER.
 5. PROVIDE REMOVABLE PIPE BOLLARDS AT EQUIPMENT ACCESS PANELS, AS REQUIRED.

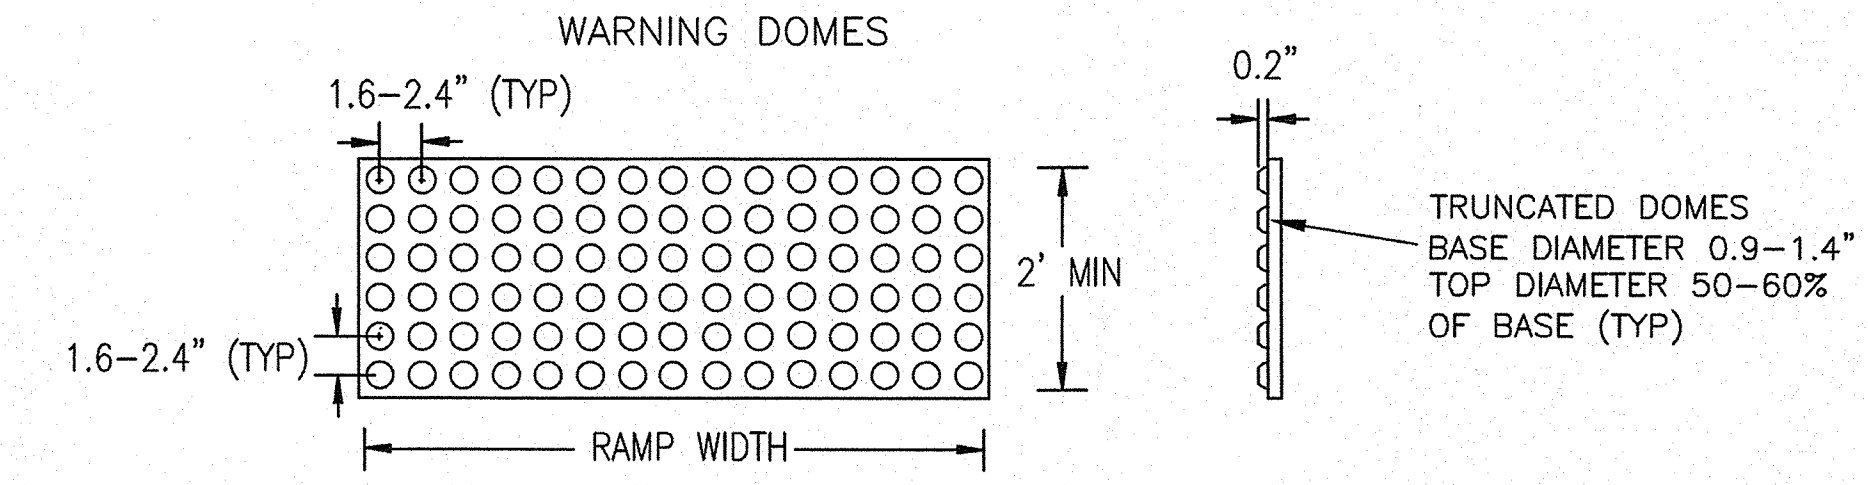

- WARNING DOME NOTES:**
1. USE CONTRASTING COLORS, RED OR BLACK ON WHITE PAVEMENT.
 2. USE CAST IN PLACE PAVERS FOR NEW CONSTRUCTION.
 3. RUBBER MATS ARE PERMITTED FOR RETROFITS.
 4. LANDING AND RAMP WIDTH MAY BE REDUCED TO 3' WHERE SPACE IS LIMITED AND DESIGN IS APPROVED BY THE CITY ENGINEER.

WARNING DOMES (APPLICABLE PART FROM CoW 3-07)
NOT TO SCALE

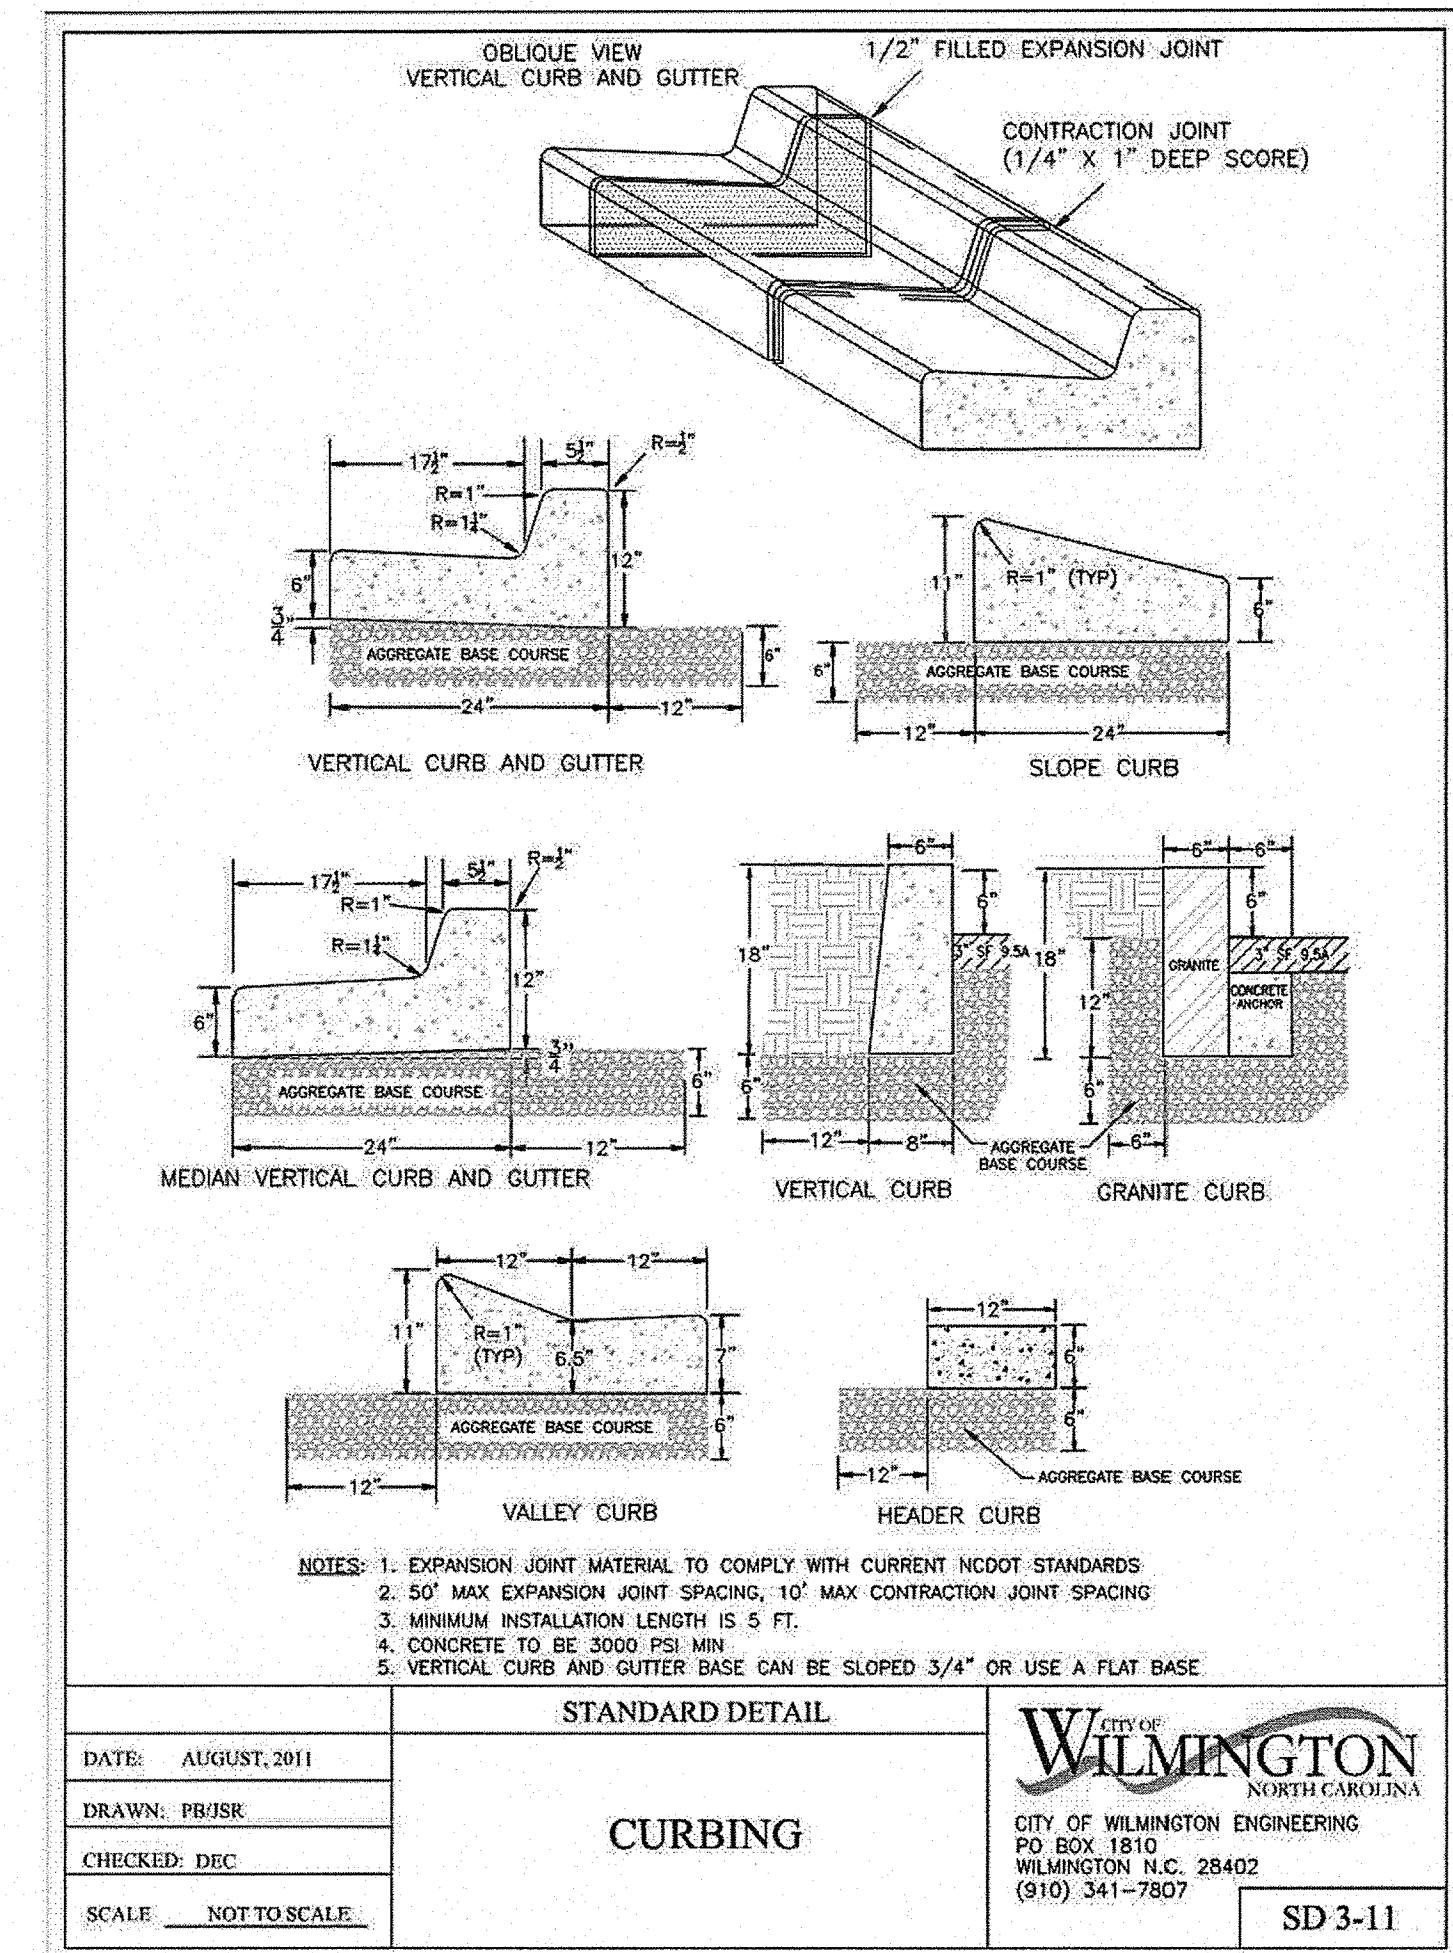


STANDARD DETAIL

CURBING


DATE: AUGUST, 2011
DRAWN: PBJSR
CHECKED: DEC
SCALE: NOT TO SCALE

CITY OF WILMINGTON
NORTH CAROLINA
CITY OF WILMINGTON ENGINEERING
P.O. BOX 1810
WILMINGTON, N.C. 28402
(910) 341-7807

SD 3-11

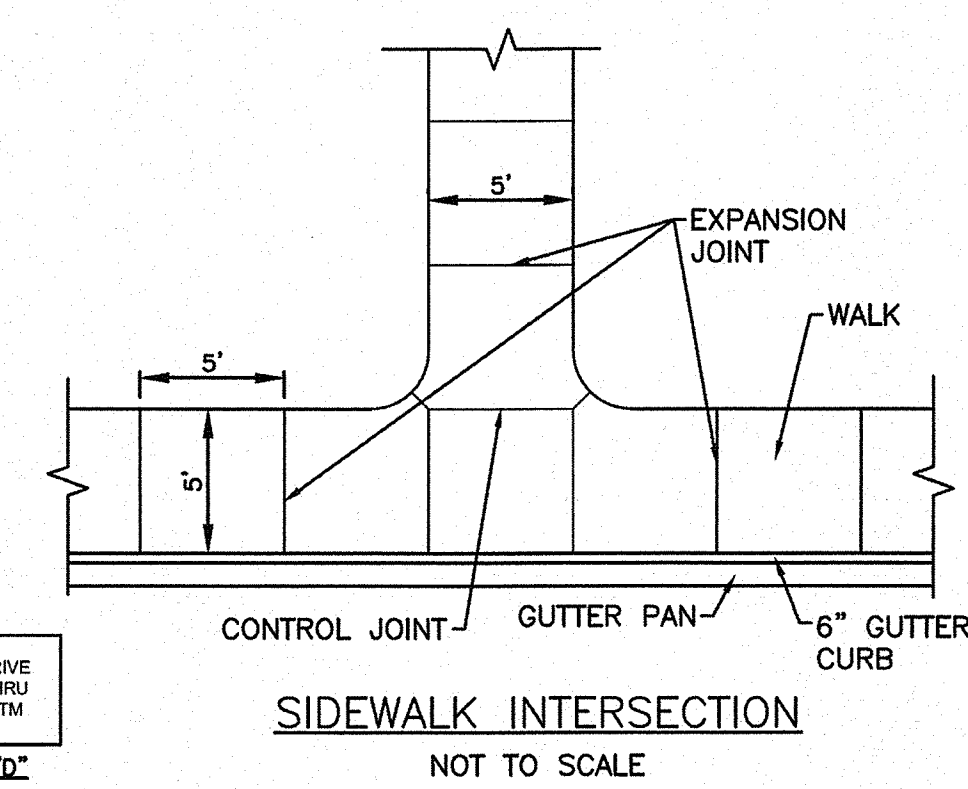

SIDEWALK INTERSECTION
NOT TO SCALE

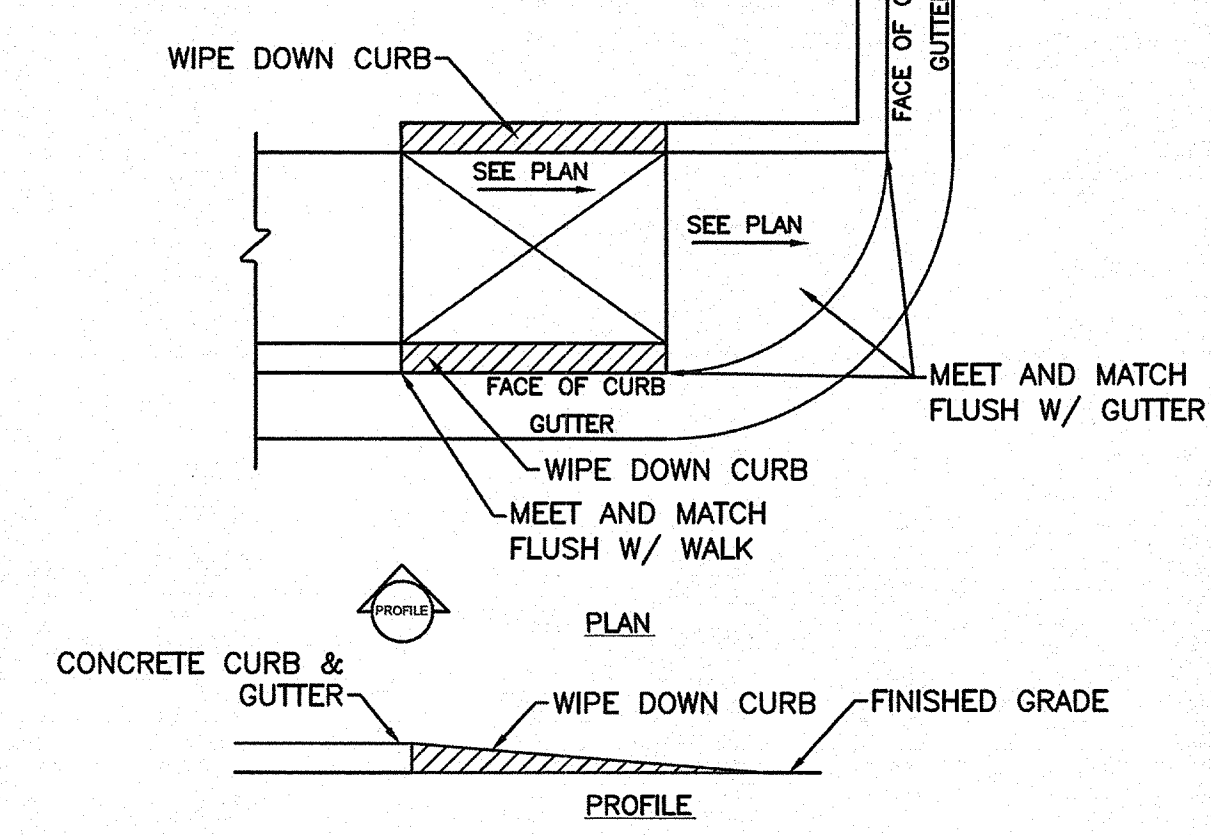

ACCESSIBLE RAMP SIDEWALK TERMINUS
NOT TO SCALE

Approved Construction Plan

Name: Nicole D Smith Date: 1/30/20

Planning: W. Smith 1-30-20

Traffic: C. Walker 1/30/20

Fire: C. Walker 1/30/20

CITY OF WILMINGTON
NORTH CAROLINA
Public Services • Engineering Division
APPROVED STORMWATER MANAGEMENT PLAN

Date: 1/30/2020 Permit # 2020003

Signed: [Signature]

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PROFESSIONAL SEAL
29419
ENGINEER
MARK T. ARCURI
Date: 1/27/2020

PROFESSIONAL SEAL
C-2197
CORPORATE
N.C.

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OWNER/DEVELOPER/APPLICANT
STATE EMPLOYEES' CREDIT UNION

ADDRESS:
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RALEIGH, NORTH CAROLINA 27603
PHONE: 919-839-5300

PROJECT
STATE EMPLOYEES' CREDIT UNION - WILMINGTON S 17th STREET BRANCH

ADDRESS:
4355 S 17TH STREET
WILMINGTON NC 28412

PROJECT MANAGER
MTA

FIELD SURVEY DATE:
02/15/19




CHECKED BY:
DM

DRAWING DATE:
12/03/2019


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KD

JOB #
SE18.191.00


SHEET
C-7.1

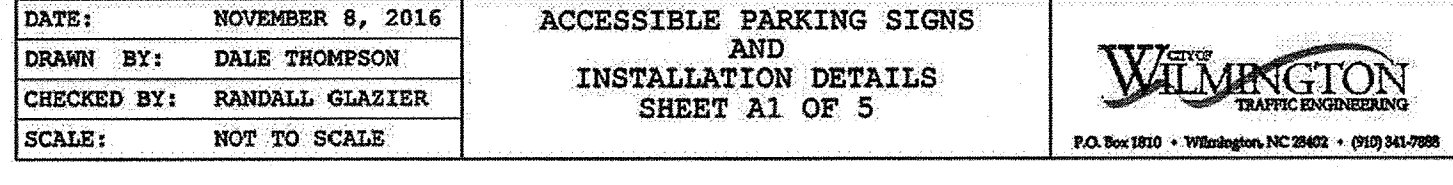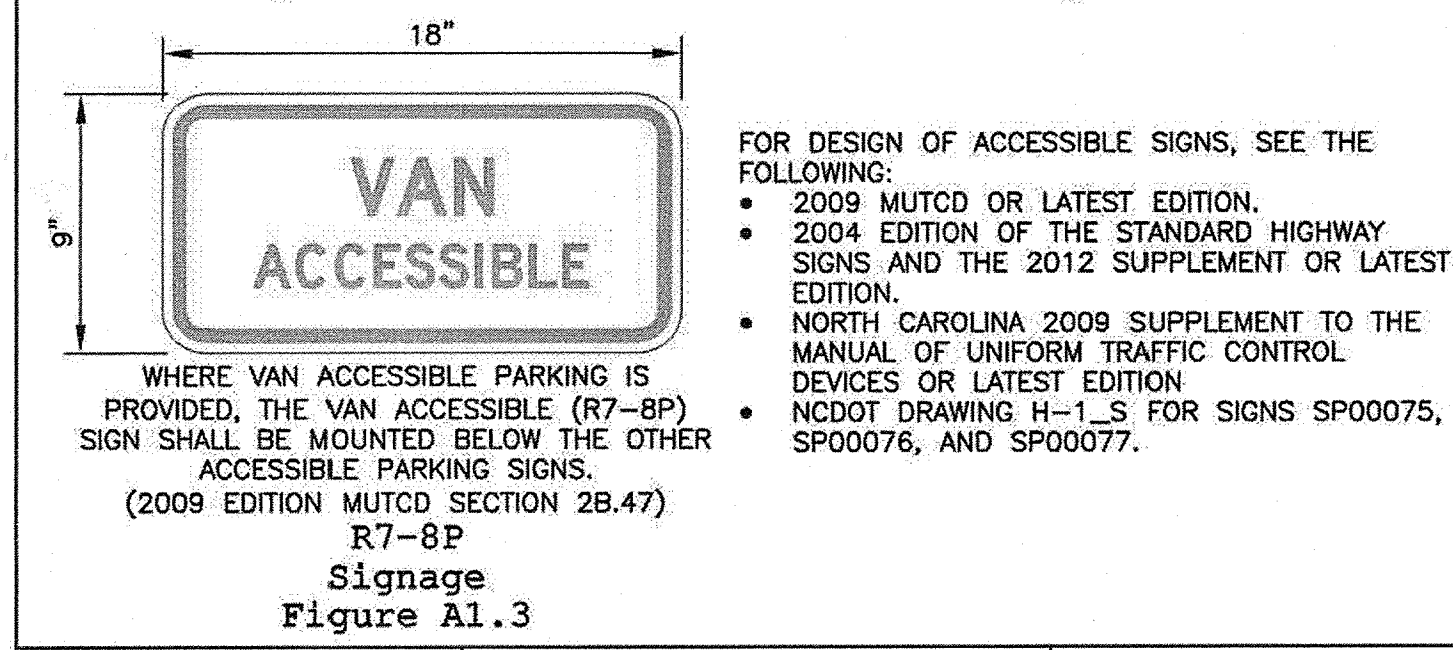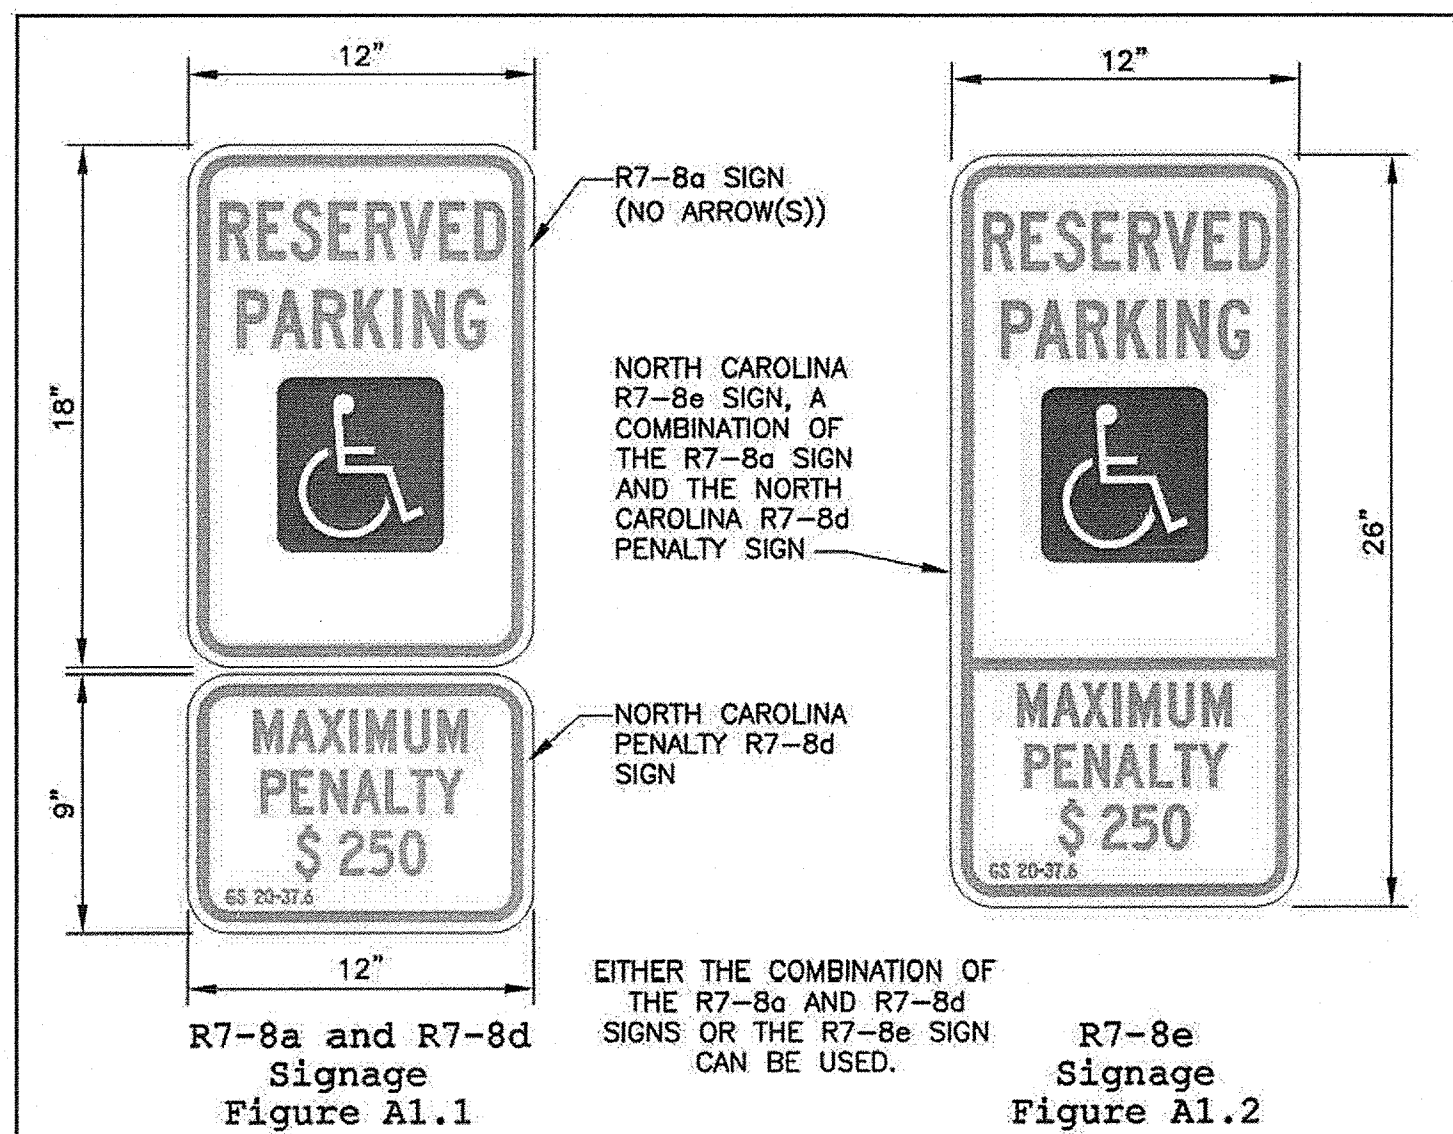




DATE: NOVEMBER 8, 2016	ACCESSIBLE PARKING SIGNS AND INSTALLATION DETAILS SHEET A1 OF 5	
DRAWN BY: DALE THOMPSON		
CHECKED BY: RANDALL GLAZIER		
SCALE: NOT TO SCALE		

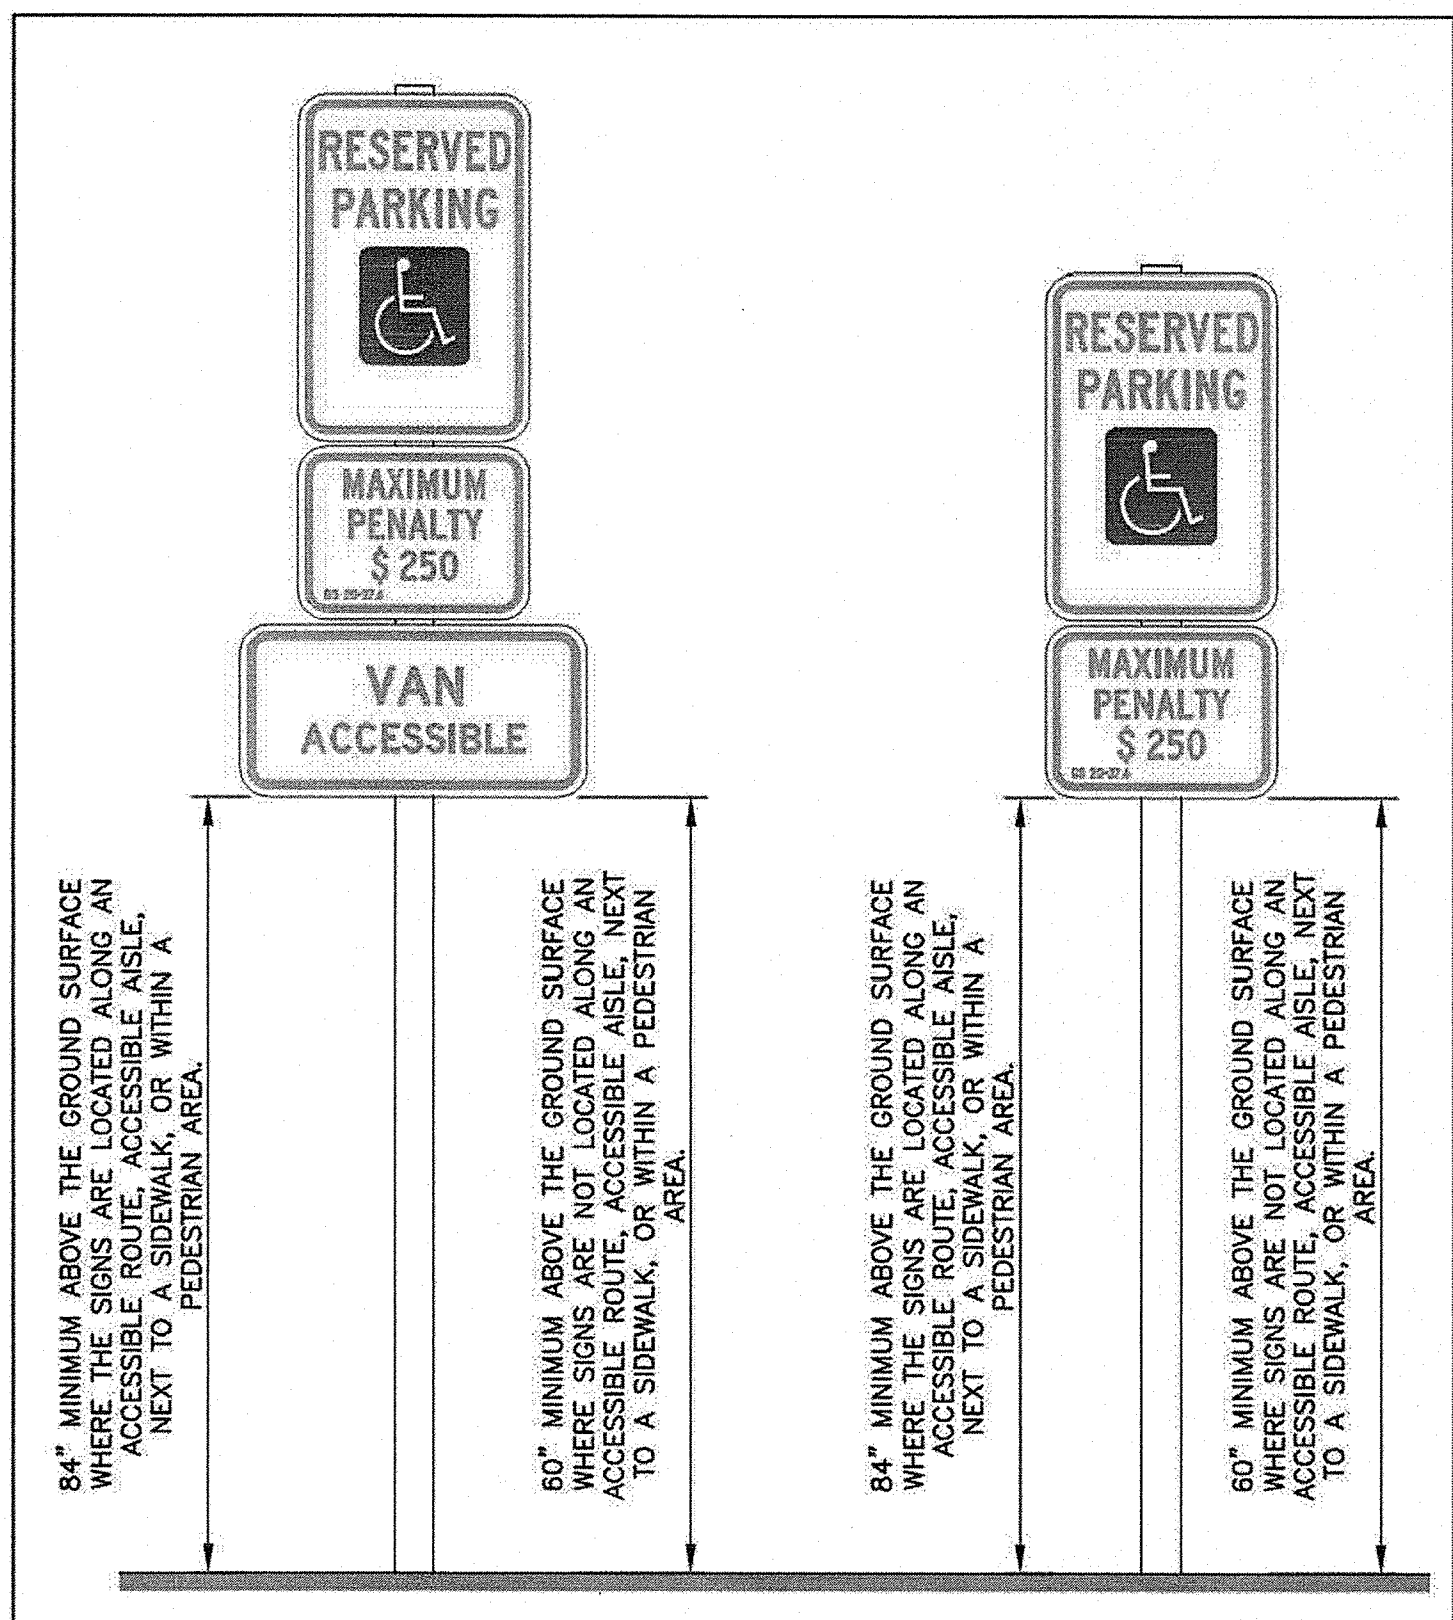

DATE: NOVEMBER 8, 2016	ACCESSIBLE PARKING SIGNS AND INSTALLATION DETAILS SHEET A2 OF 5	
DRAWN BY: DALE THOMPSON		
CHECKED BY: RANDALL GLAZIER		
SCALE: NOT TO SCALE		




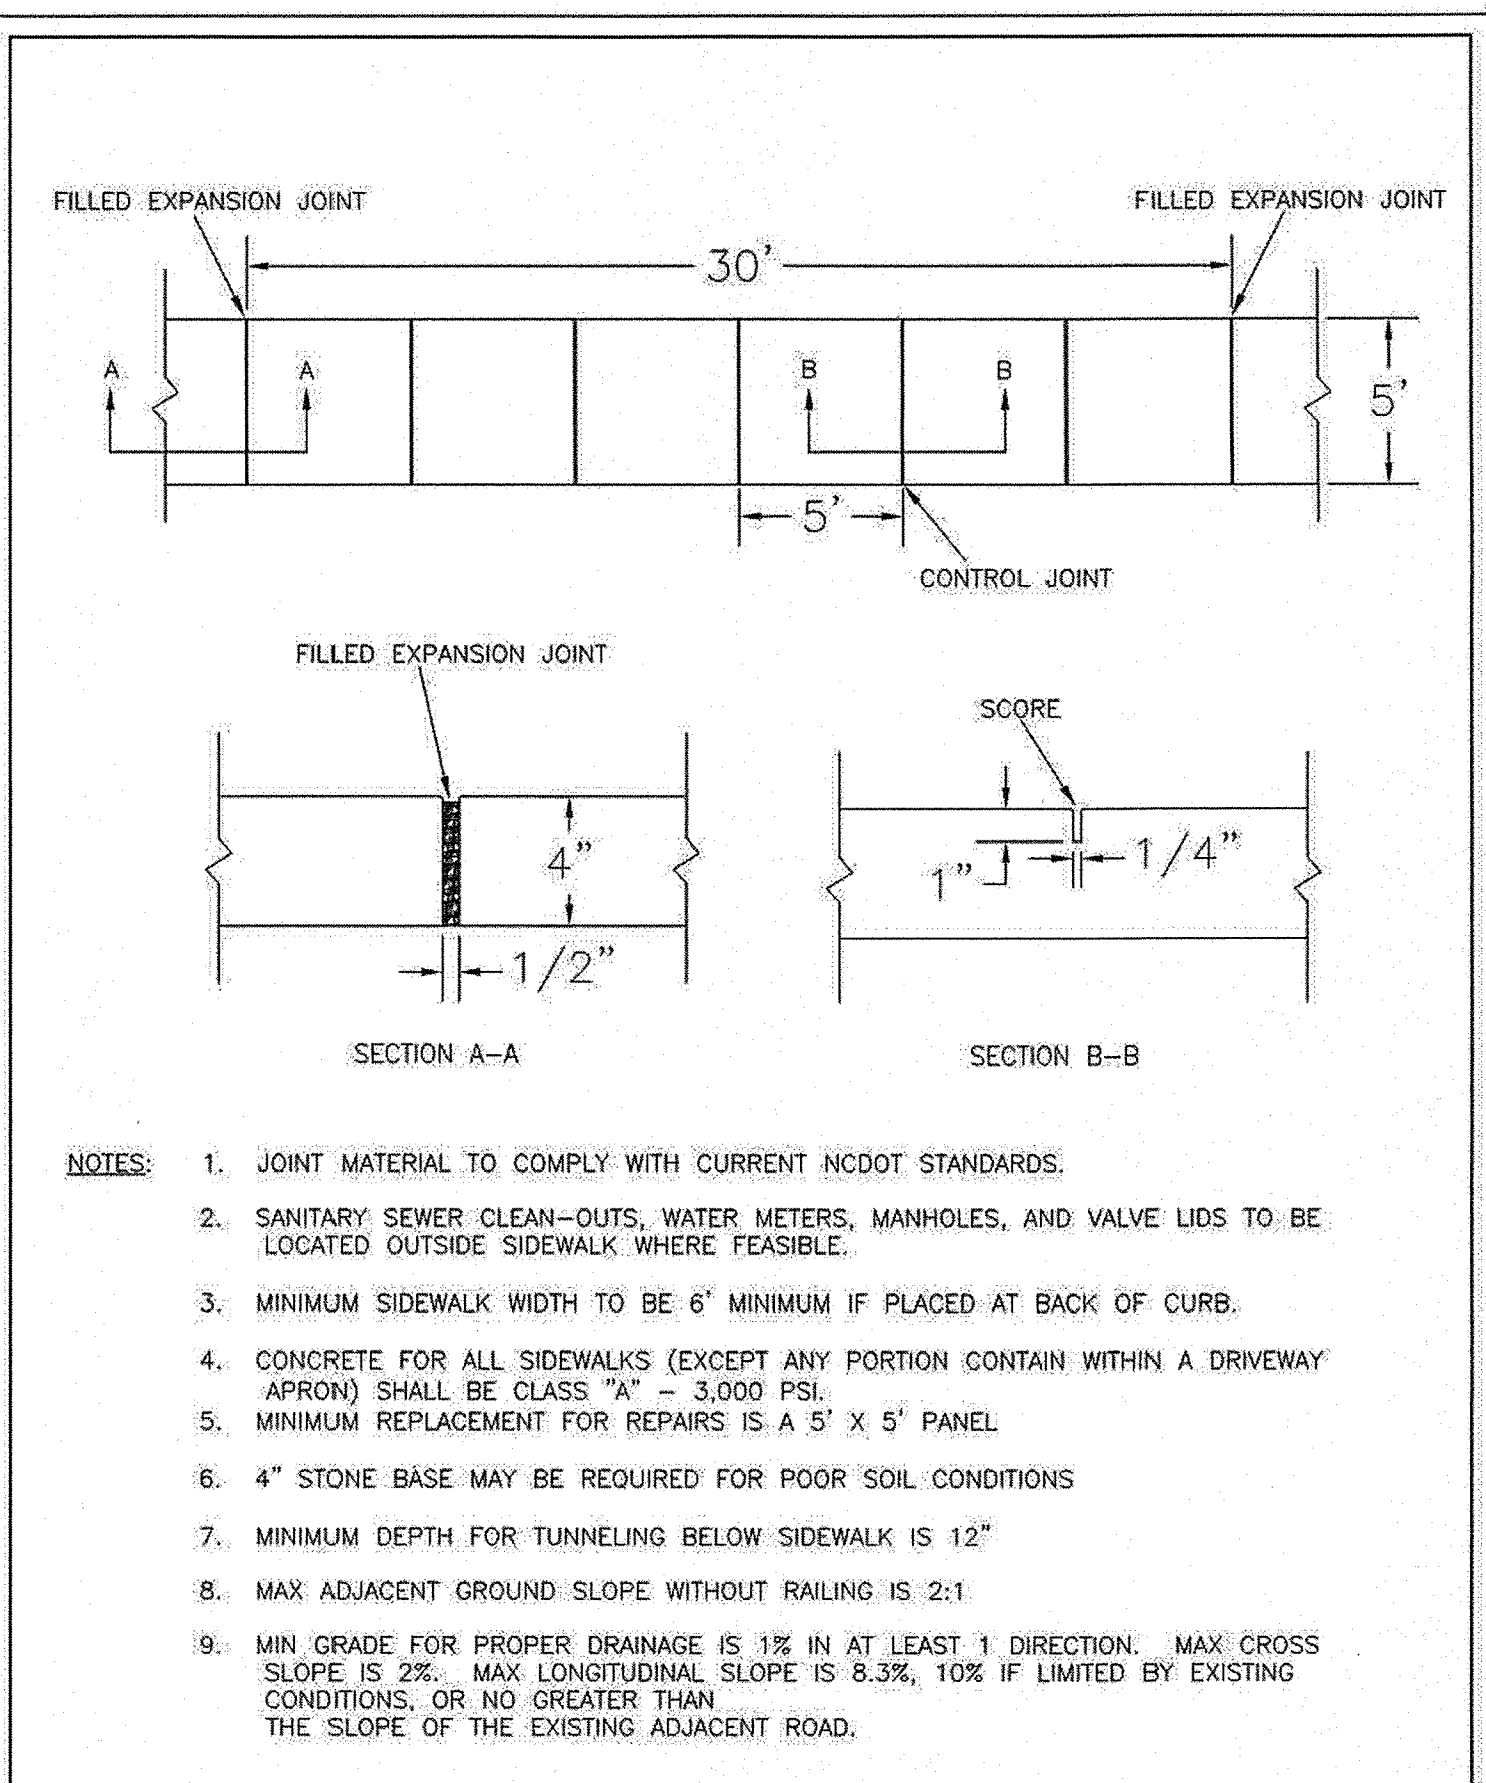


DATE: OCTOBER, 2010	STANDARD DETAIL	
DRAWN: PBJ/SR	SIDEWALK	
CHECKED: DEC		
SCALE: NOT TO SCALE		SD 3-10

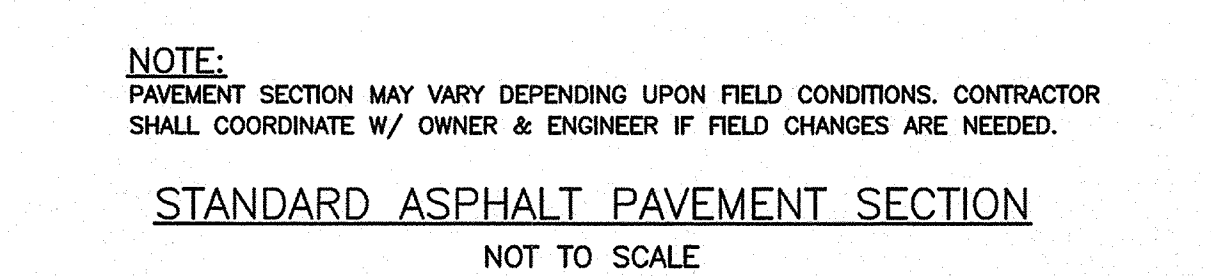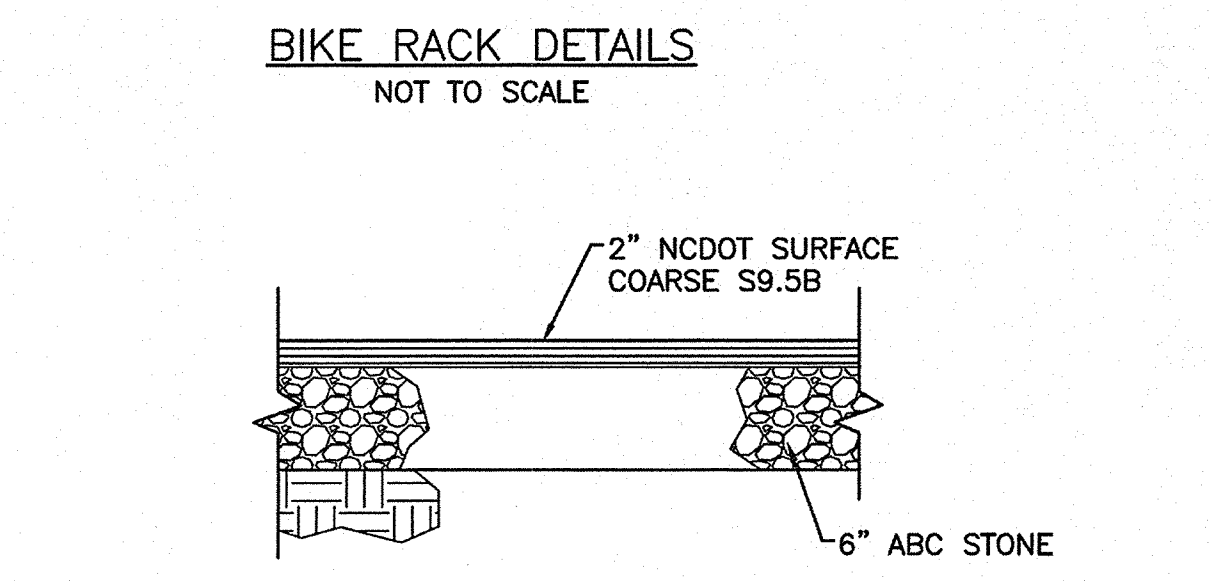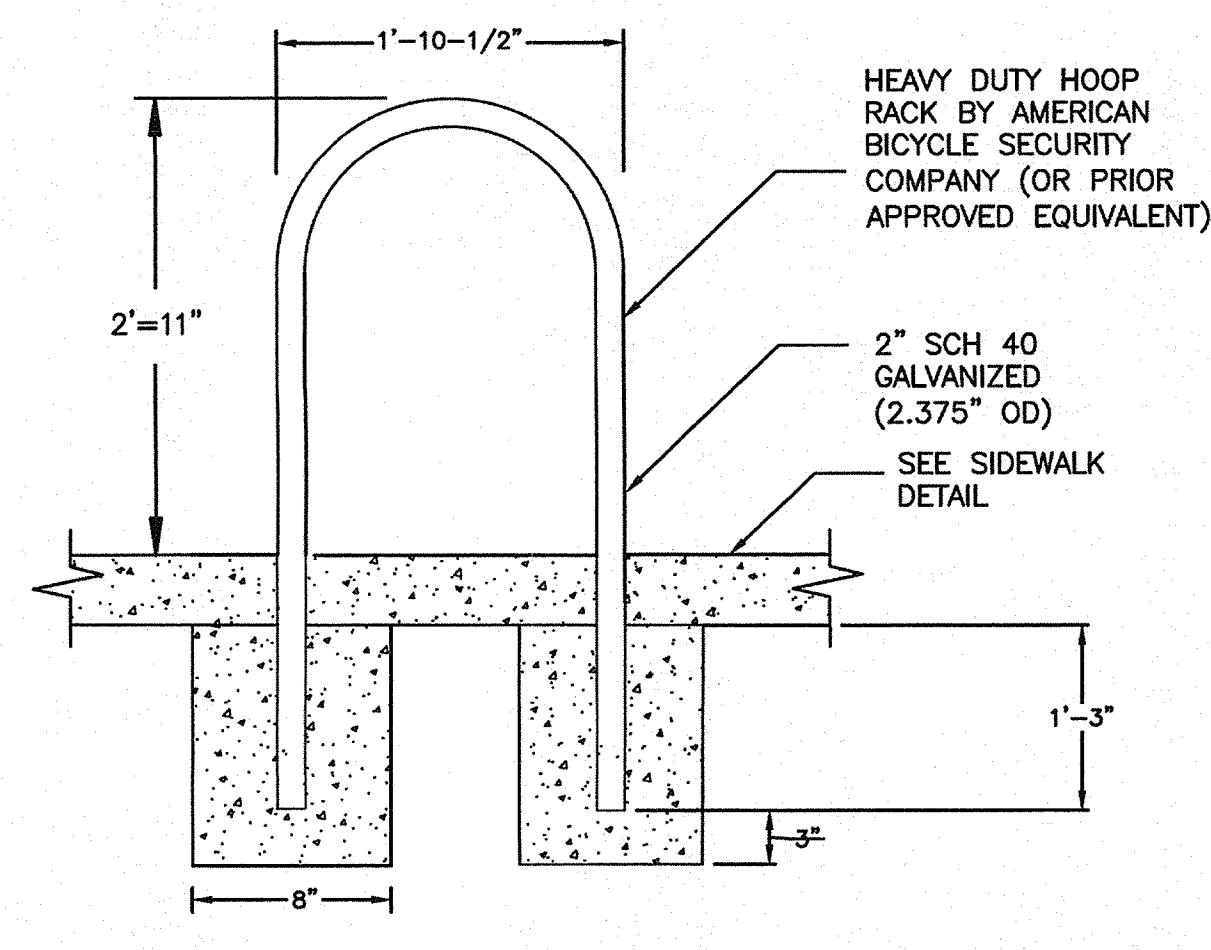

NOTE: PAVEMENT SECTION MAY VARY DEPENDING UPON FIELD CONDITIONS. CONTRACTOR SHALL COORDINATE W/ OWNER & ENGINEER IF FIELD CHANGES ARE NEEDED.

HEAVY DUTY ASPHALT PAVEMENT SECTION NOT TO SCALE

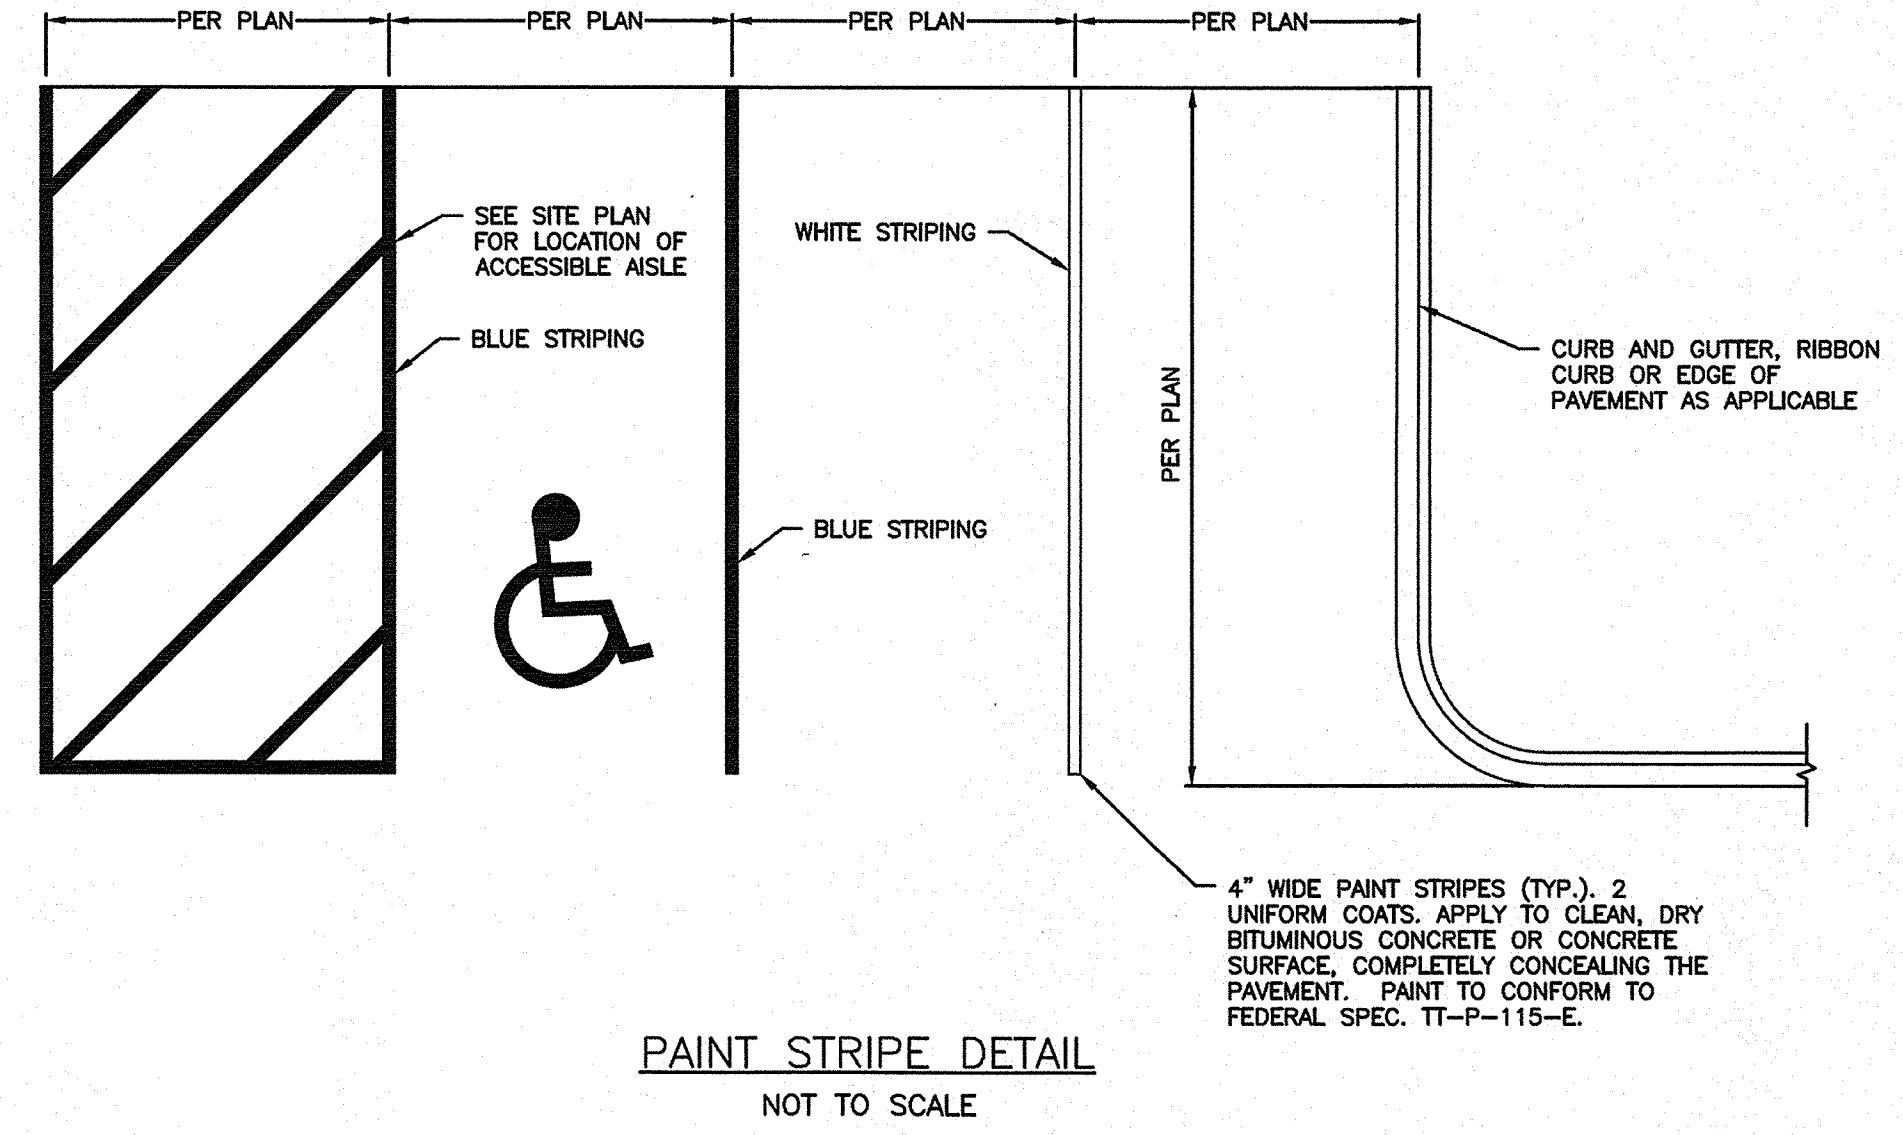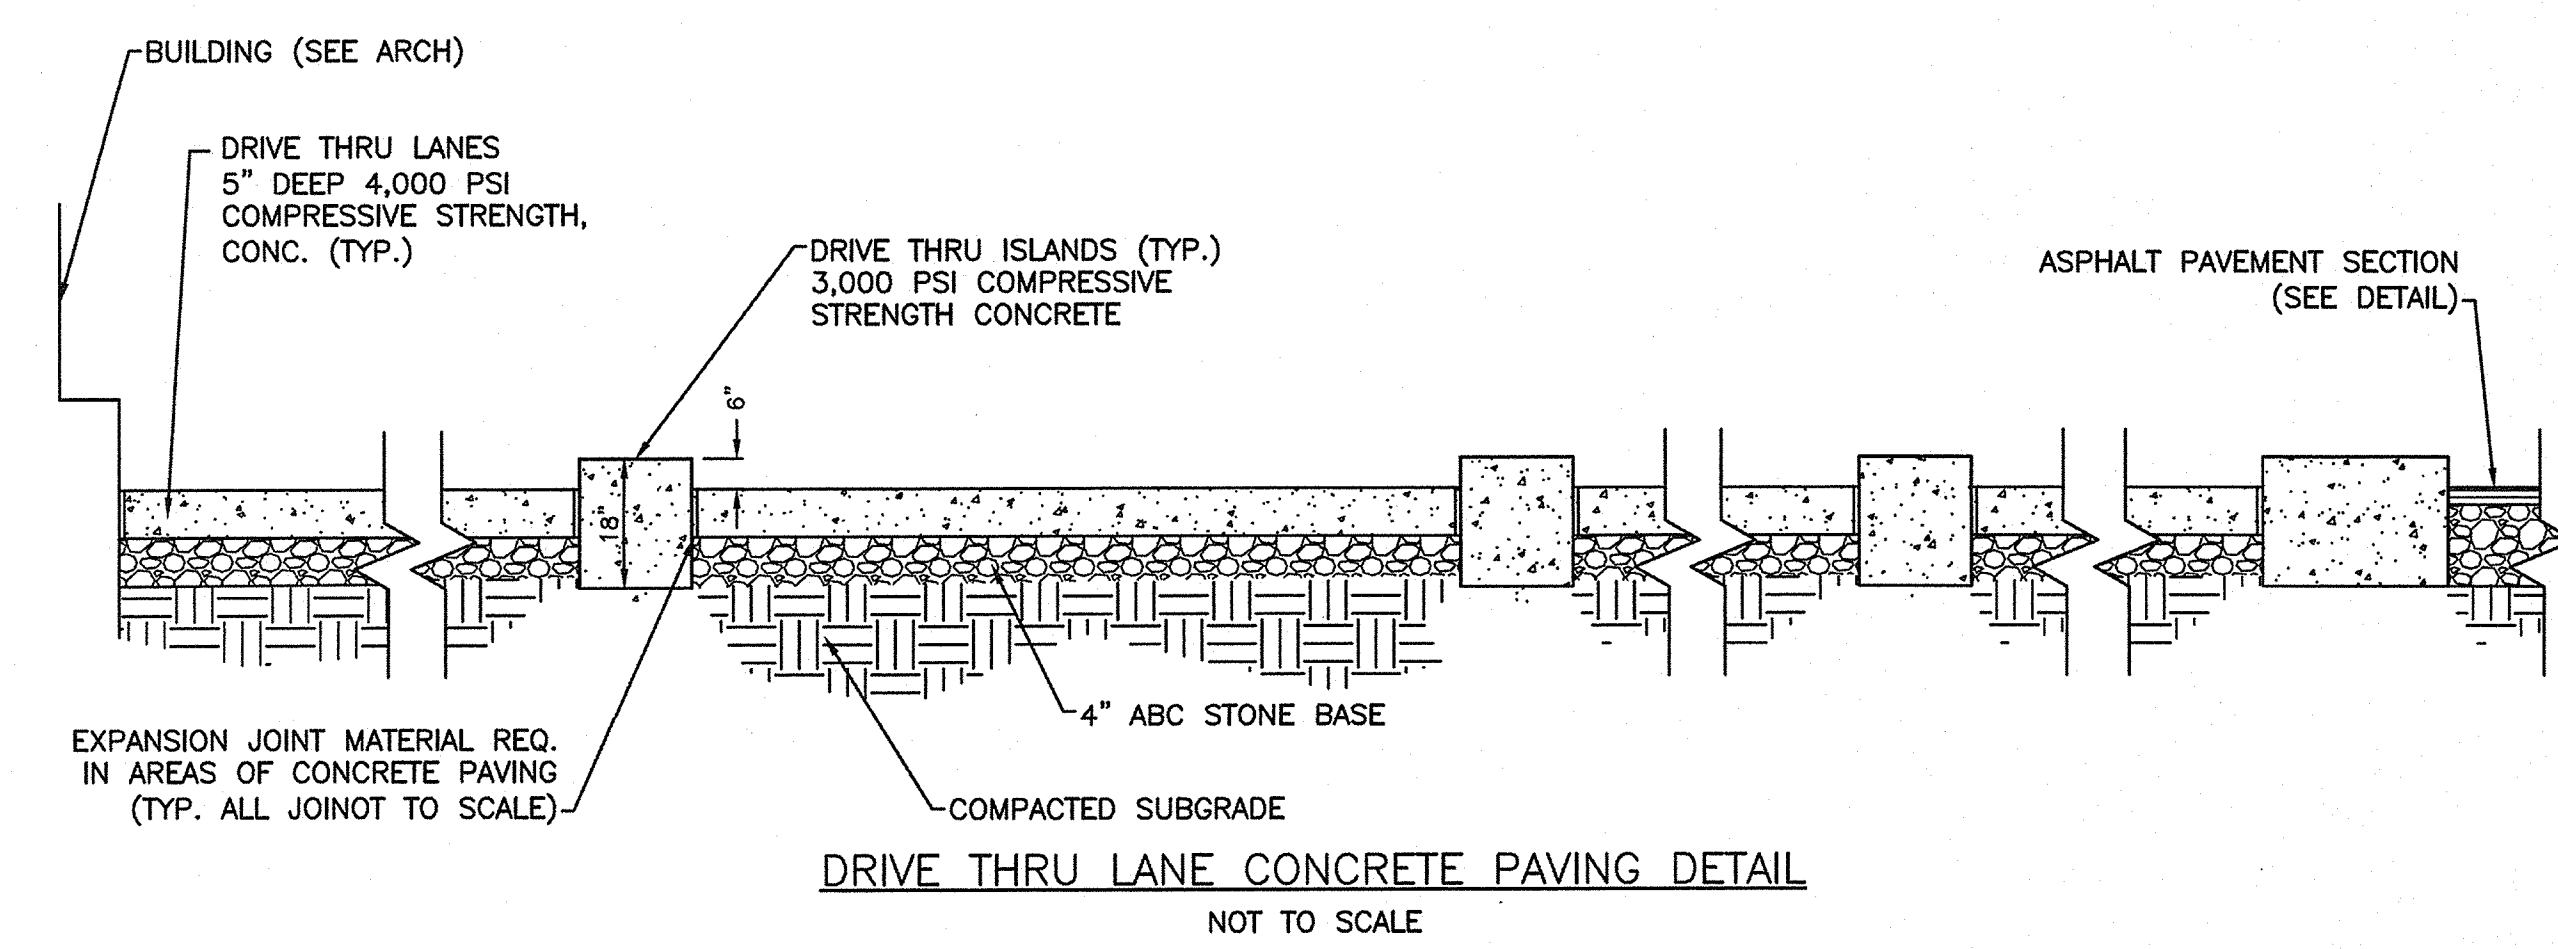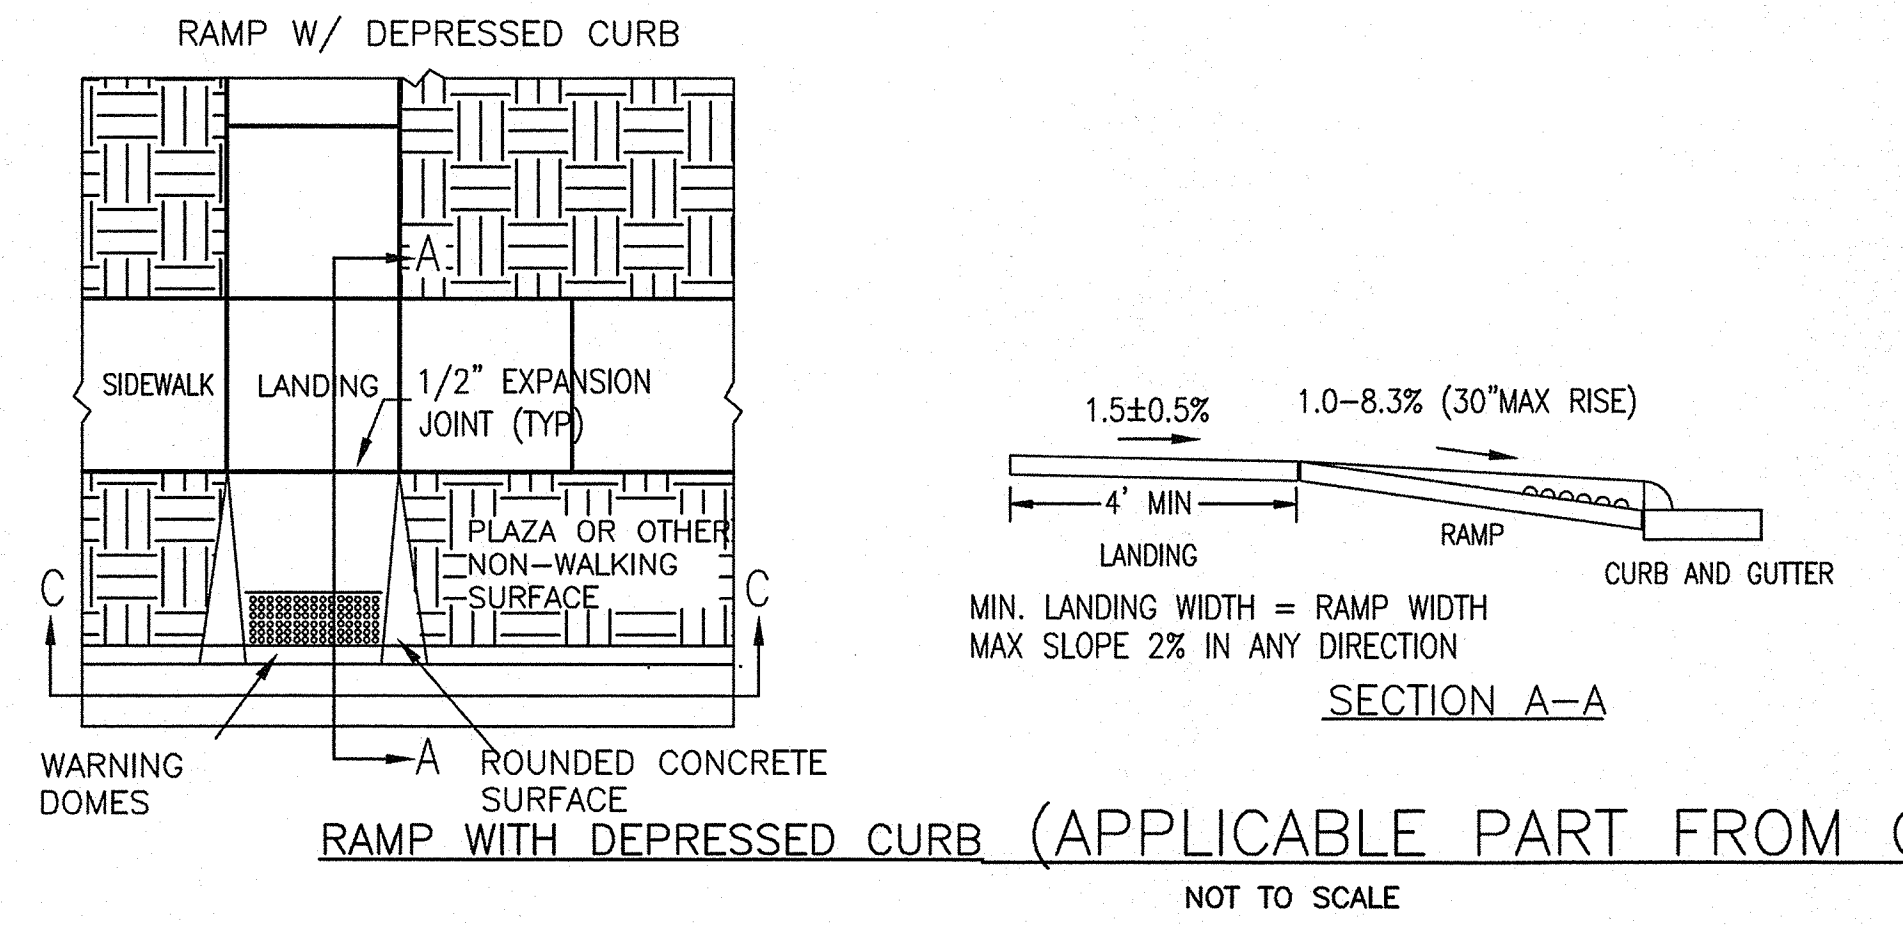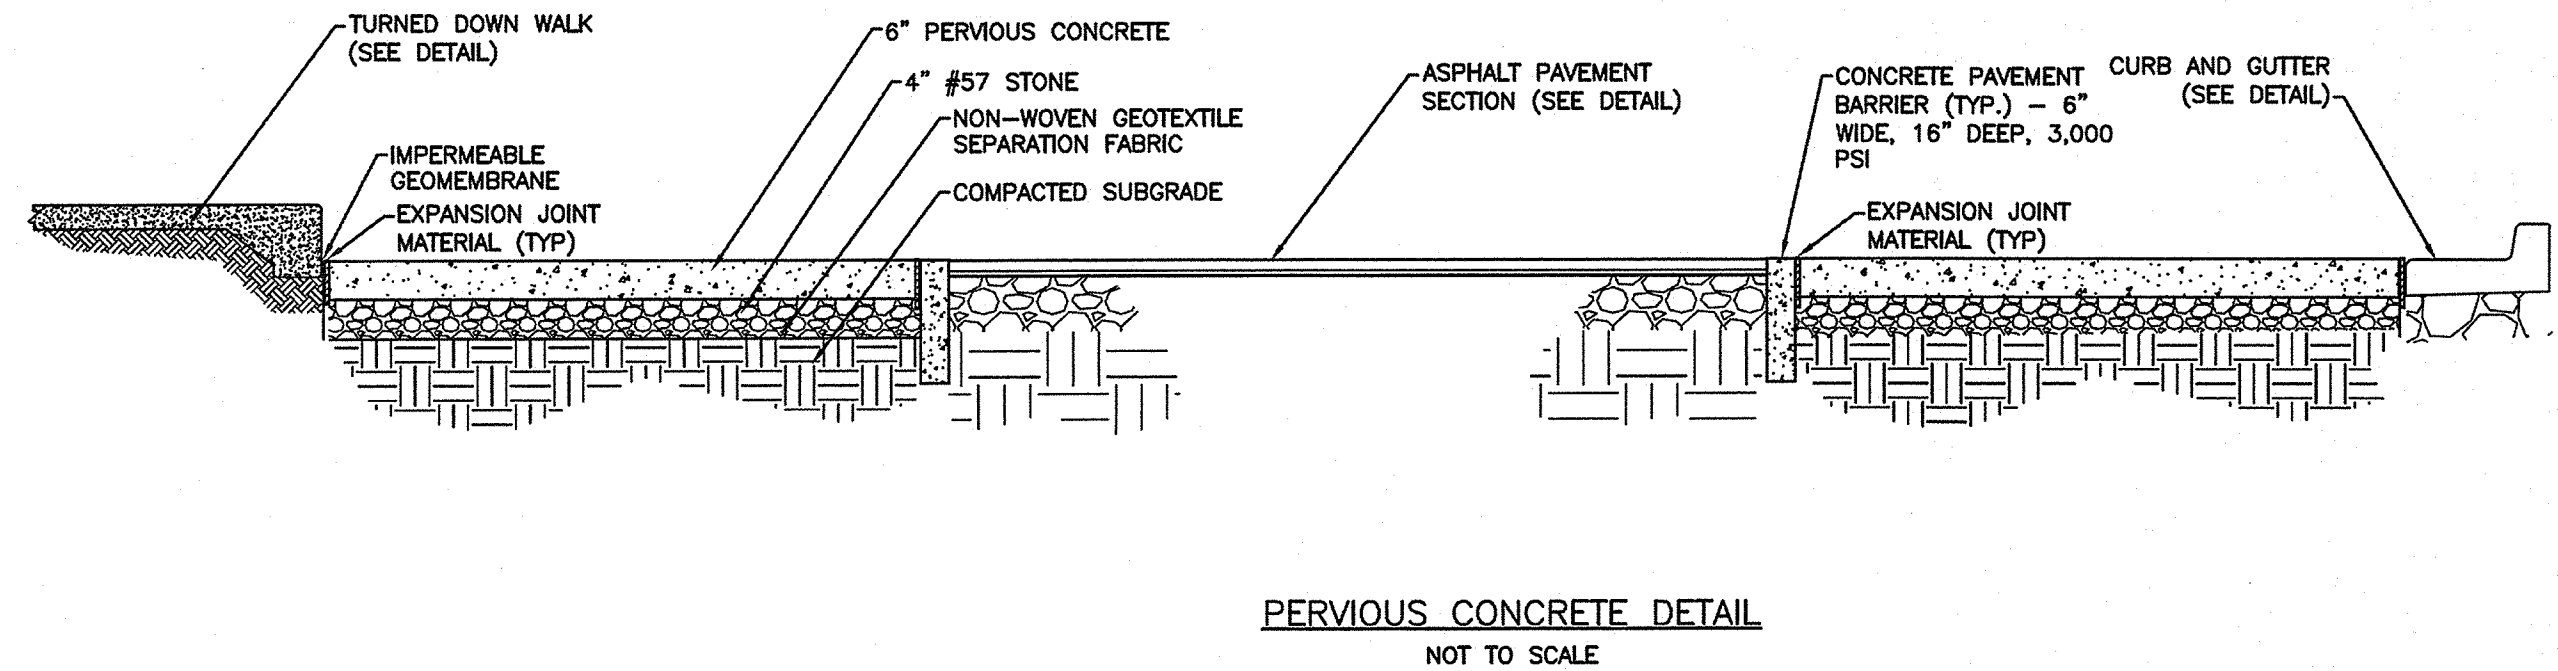

SEPI
 1 GLENWOOD AVE, SUITE 600
 RALEIGH, NC 27603
 PHONE 919.789.9977
 11020 DAVID TAYLOR DR., SUITE 115
 CHARLOTTE, NC 28262
 PHONE 704.714.4880
 5030 NEW CENTRE DR., SUITE B
 WILMINGTON, NC 28403
 PHONE 910.523.5715
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 Know what's below.
 Call before you dig.
 3 WORKING DAYS
 BEFORE YOU DIG
 FOR THE LOCATION OF
 UNDERGROUND FACILITIES

THE LOCATION OF EXISTING UNDERGROUND UTILITIES ARE SHOWN ON AN APPROXIMATE PLAN ONLY AND DOES NOT REPRESENT THE EXACT LOCATION OF ALL EXISTING UTILITIES. THE CONTRACTOR SHALL DETERMINE THE EXACT LOCATION OF ALL EXISTING UTILITIES BEFORE COMMENCING WORK, AND AGREES TO BE FULLY RESPONSIBLE FOR ANY AND ALL DAMAGES WHICH MAY BE OCCURRED BY THE CONTRACTOR'S FAILURE TO EXACTLY LOCATE AND PRESERVE ANY AND ALL UNDERGROUND UTILITIES.

NOTICE: CONSTRUCTION SITE SAFETY IS THE SOLE RESPONSIBILITY OF THE CONTRACTOR. WITHIN THE OWNER'S RIGHT THE CONTRACTOR SHALL BE EXPECTED TO ASSUME ANY RESPONSIBILITY FOR SAFETY OF THE WORK, IF PERSONS INJURED OR THE WORK OF ANY NEARBY STRUCTURES, OR OF ANY OTHER PERSONS.

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OWNER/DEVELOPER/APPLICANT
STATE EMPLOYEES' CREDIT UNION
 ADDRESS: 119 N. SALISBURY STREET RALEIGH, NORTH CAROLINA 27603 PHONE: 919-838-5300

PROJECT MANAGER
STATE EMPLOYEES' CREDIT UNION - WILMINGTON
 5 17TH STREET WILMINGTON NC 28412
 ADDRESS: 4355 S 17TH STREET WILMINGTON NC 28412


APPROVED CONSTRUCTION PLAN
 Name: Nicole Smith Date: 1/30/20
 Planning: Nicole Smith Traffic: W. Matthews Fire: C. Welch
 Date: 1/30/2020 Permit # 2020003
 Signed: Josh Christensen

Public Services • Engineering Division
 APPROVED STORMWATER MANAGEMENT PLAN
 Date: 1/30/2020 Permit # 2020003
 Signed: Josh Christensen

FIELD SURVEY DATE: 02/15/19
 CHECKED BY: DM DRAWING DATE: 12/09/2019
 DRAWN BY: KD JOB # SE1819100

For each open utility cut of City streets, a \$325 permit shall be required from the City prior to occupancy and/or project acceptance

SHEET
C-7.2

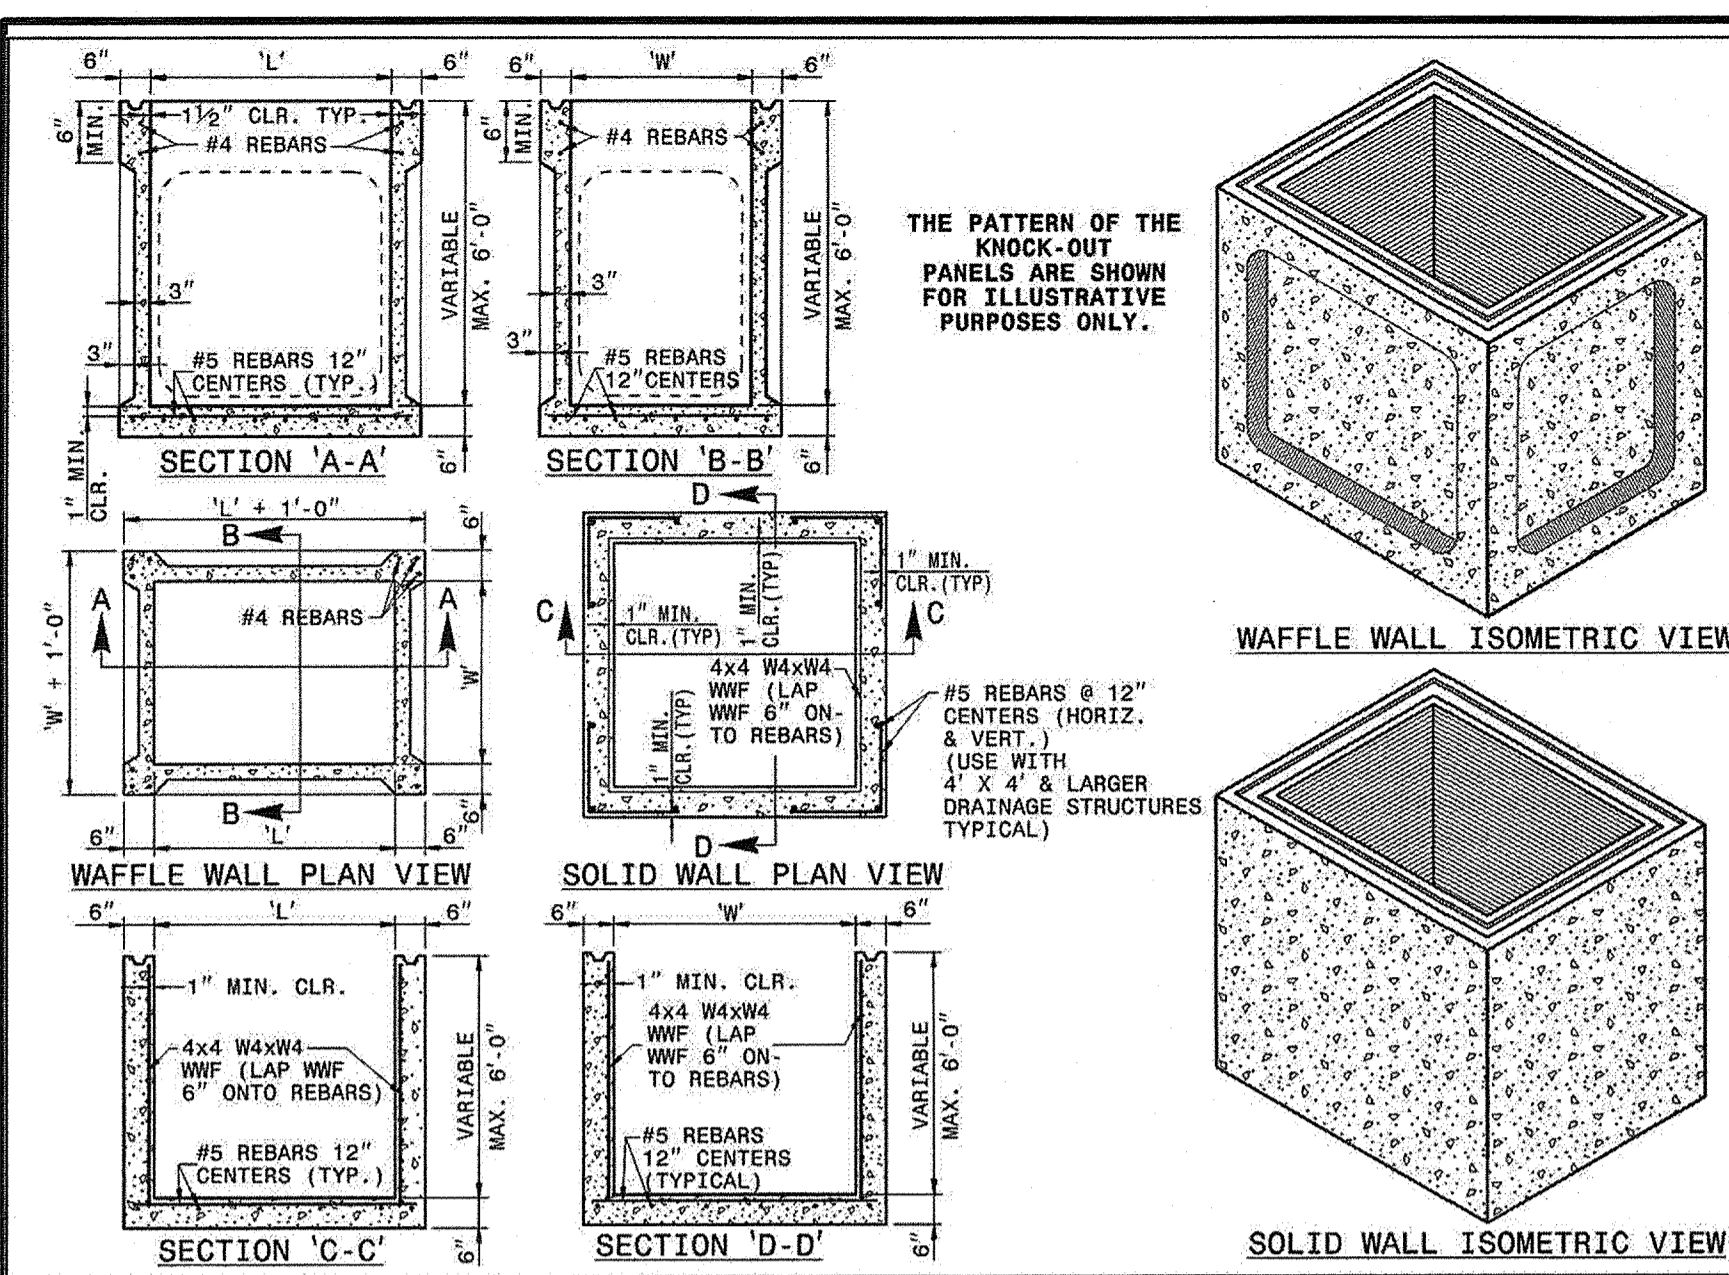


GENERAL NOTES:

- THIS PRECAST BOX MAY BE USED FOR THE FOLLOWING STANDARDS: 840.01, 840.02, 840.04, 840.05, 840.13, 840.14, 840.15, 840.17, 840.18, 840.19, 840.26, 840.27, 840.28, 840.31, 840.32 AND 840.41.
- INSTALL PRECAST DRAINAGE STRUCTURES AND PAY FOR IN ACCORDANCE WITH SPECIFICATION SECTION 840.
- DO NOT PLACE PRECAST DRAINAGE STRUCTURES UNDER TRAFFIC OR WHERE TRAFFIC WILL BE DETOURED.
- USE 4000 PSI CONCRETE.
- PROVIDE ALL REINFORCING STEEL WHICH MEETS ASTM A615 FOR GRADE 60 AND WELDED WIRE FABRIC CONFORMING TO ASTM A1064.
- LIMIT MAXIMUM DEPTH TO TOP OF BOTTOM SLAB FOR WAFFLE WALL STRUCTURE TO 10'-0". LIMIT SOLID WALL STRUCTURE TO 15'-0".
- PLACE LIFT HOLES OR PINS IN ACCORDANCE WITH OSHA STANDARD 1926.704.
- CUT OR FORM OPENINGS FOR PIPE TO PROVIDE REQUIRED SIZE AND LOCATION. ORIENT WAFFLE WALL STRUCTURES SO THAT PIPES ENTER THROUGH THE KNOCKOUT/WAFFLE PANELS ONLY. PIPES MAY ENTER THROUGH THE CORNERS OF SOLID WALL BOXES IF A MINIMUM OF 6" OF WALL IS PROVIDED ABOVE THE HOLE.
- ALL ELEMENTS PRECAST TO MEET ASTM C913.
- FRAME AND GRATE HEIGHT MAY BE ADJUSTED WITH CONCRETE OR BRICK IN ACCORDANCE WITH STANDARD 840.25.
- PROVIDE PRECAST STRUCTURES OVER 4'-0" IN DEPTH WITH STEPS AS DIRECTED BY THE ENGINEER.
- WELDED WIRE FABRIC MAY BE SUBSTITUTED FOR REBAR AS LONG AS THE SAME AREA OF STEEL IS PROVIDED.
- SEAL JOINTS WITH A FLEXIBLE BUTYL RUBBER BASE CONFORMING TO FEDERAL SPECIFICATION SS-S-21A, AASHTO M-198, TYPE B - BUTYL RUBBER.
- LIMIT MAXIMUM STRUCTURE SIZE TO INSIDE CLEAR DIMENSIONS OF 6'0" X 6'0".
- THE OUTSIDE PIPE DIAMETER PLUS 2" OR THE OPENING REQUIRED FOR FRAME AND GRATE IS THE MINIMUM STRUCTURE SIZE WHICHEVER IS GREATER.
- USE MANHOLE FRAME AND COVER AS INDICATED ON THE PLANS. REINFORCE OPENINGS AS SHOWN ON THIS SHEET.

ROADWAY STANDARD DRAWING FOR PRECAST DRAINAGE STRUCTURE (SOLID AND WAFFLE WALL)

STATE OF NORTH CAROLINA DEPT. OF TRANSPORTATION DIVISION OF HIGHWAYS RALEIGH, N.C.

SHEET 1 OF 2 840.45

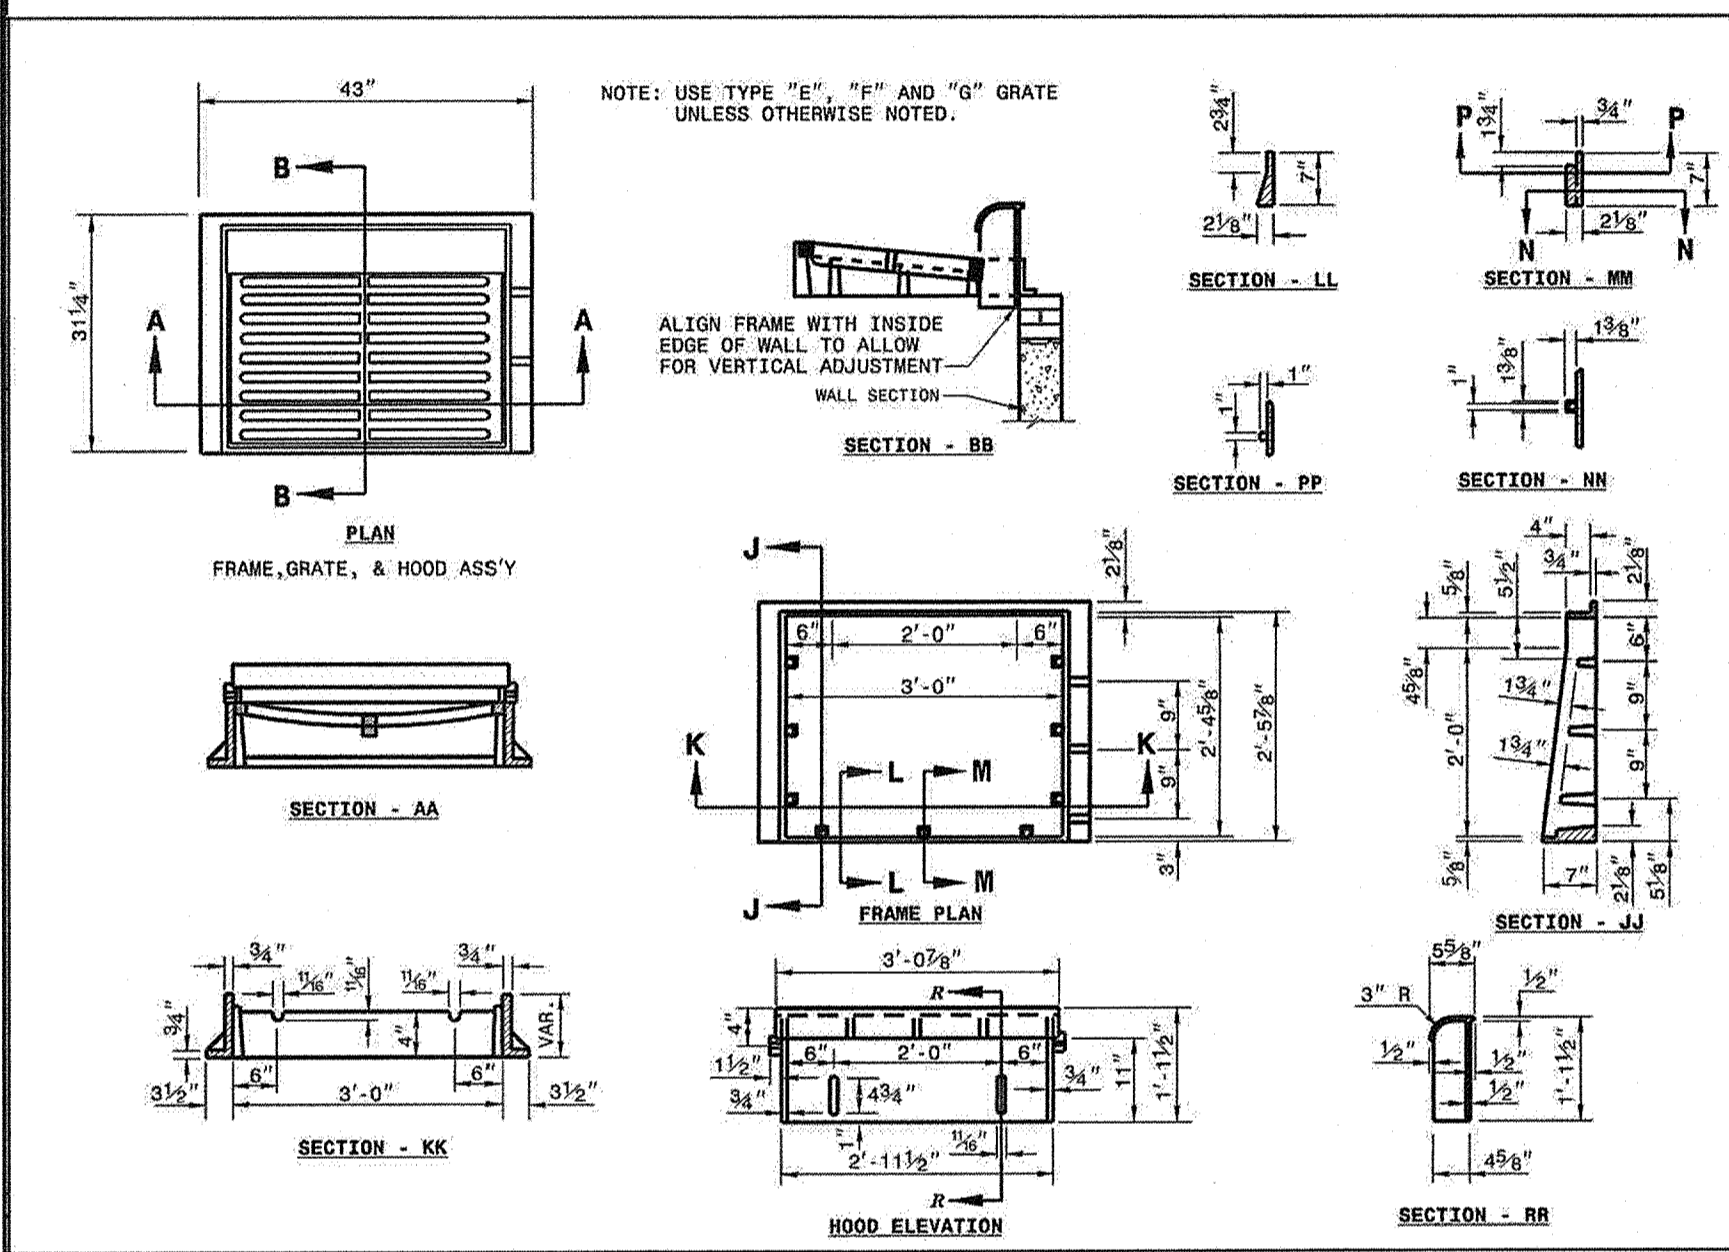

DETAIL SHOWING TYPES OF GRATES USE ACCORDING TO WATER FLOW.

NOTE: USE TYPE "E", "F" AND "G" GRATE UNLESS OTHERWISE NOTED.

ALIGN FRAME WITH INSIDE EDGE OF WALL TO ALLOW FOR VERTICAL ADJUSTMENT WALL SECTION


RAISED FLOW ARROW 1/8" HIGH

RAISED FLOW ARROW 3/16" HIGH

ROADWAY STANDARD DRAWING FOR FRAME, GRATES, AND HOOD FOR USE ON STANDARD CATCH BASIN

STATE OF NORTH CAROLINA DEPT. OF TRANSPORTATION DIVISION OF HIGHWAYS RALEIGH, N.C.



SHEET 1 OF 2 840.03

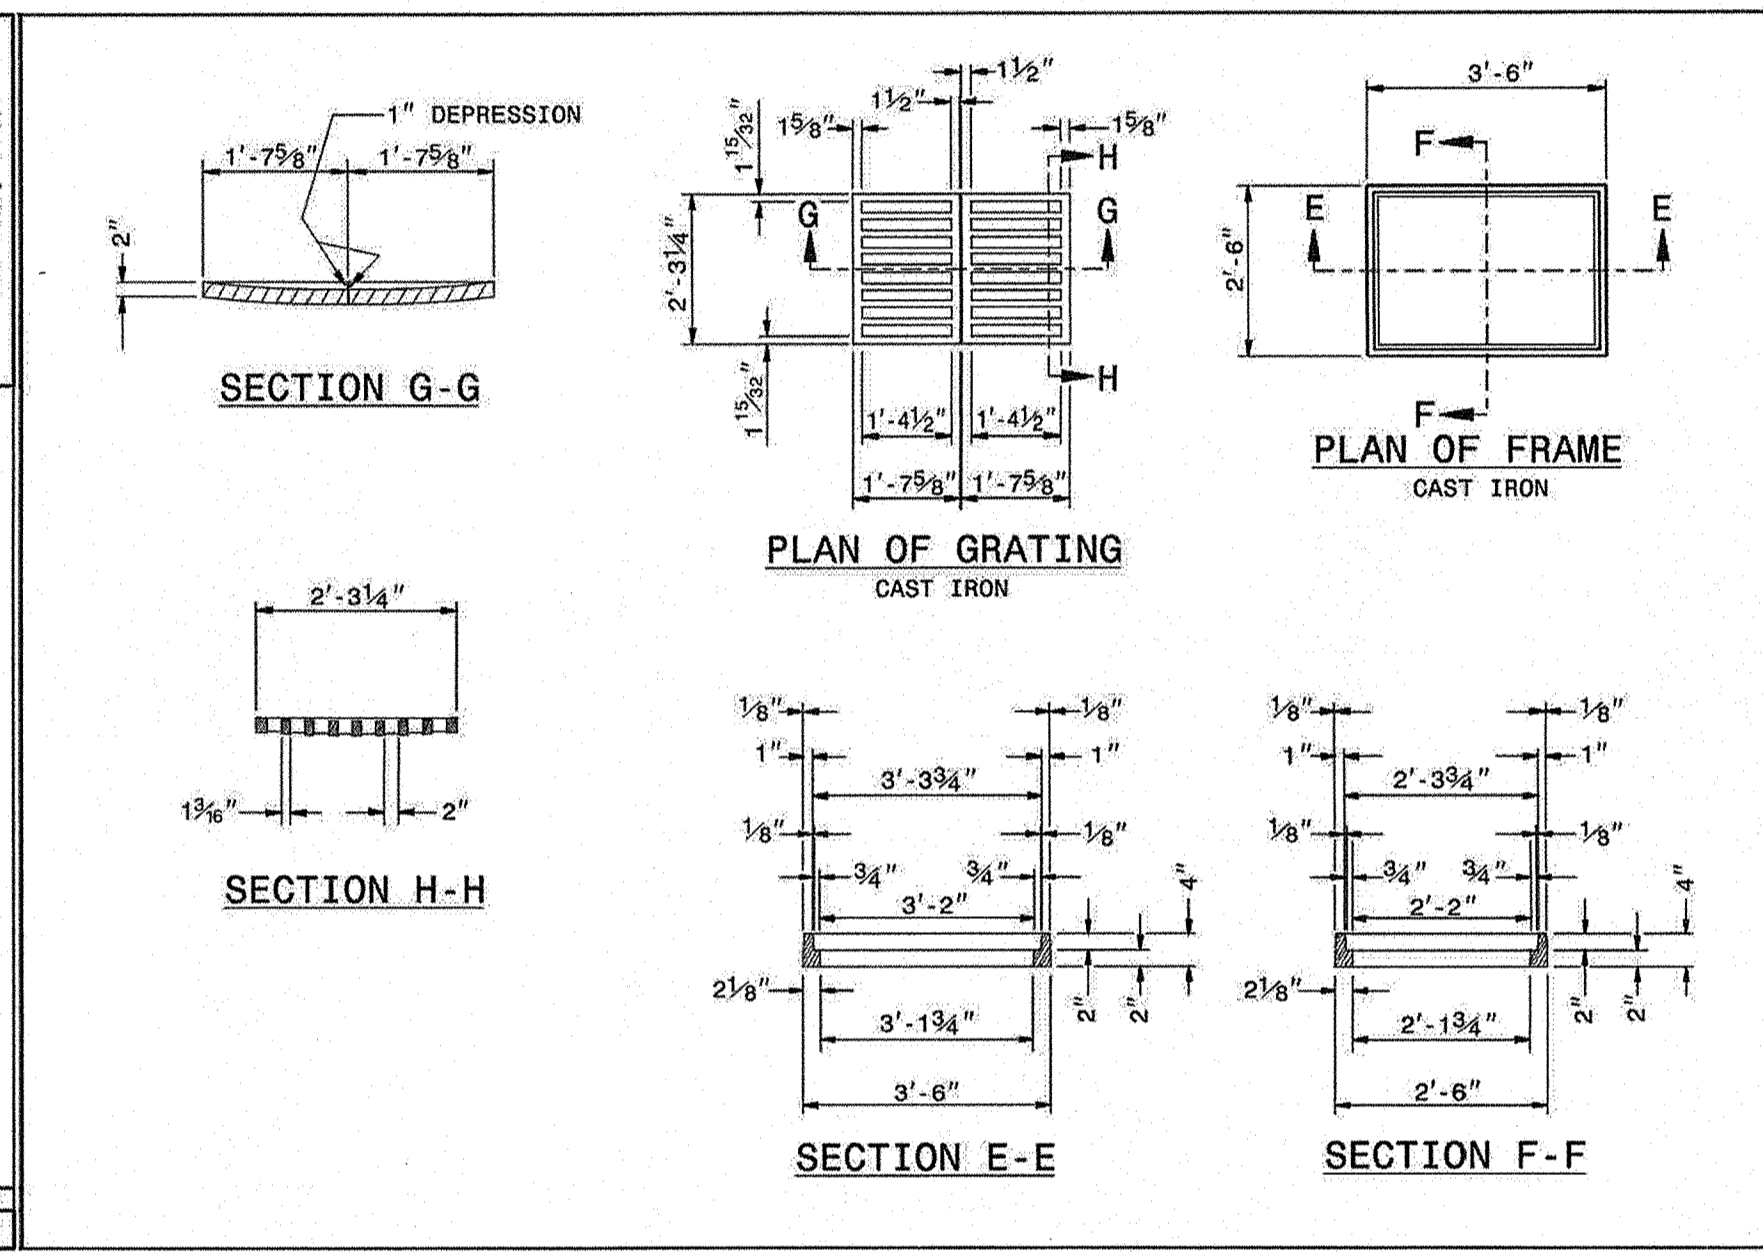

ROADWAY STANDARD DRAWING FOR DROP INLET FRAME AND GRATES FOR USE WITH STD. DMS 840.14 AND 840.15

STATE OF NORTH CAROLINA DEPT. OF TRANSPORTATION DIVISION OF HIGHWAYS RALEIGH, N.C.

SHEET 1 OF 1 840.16

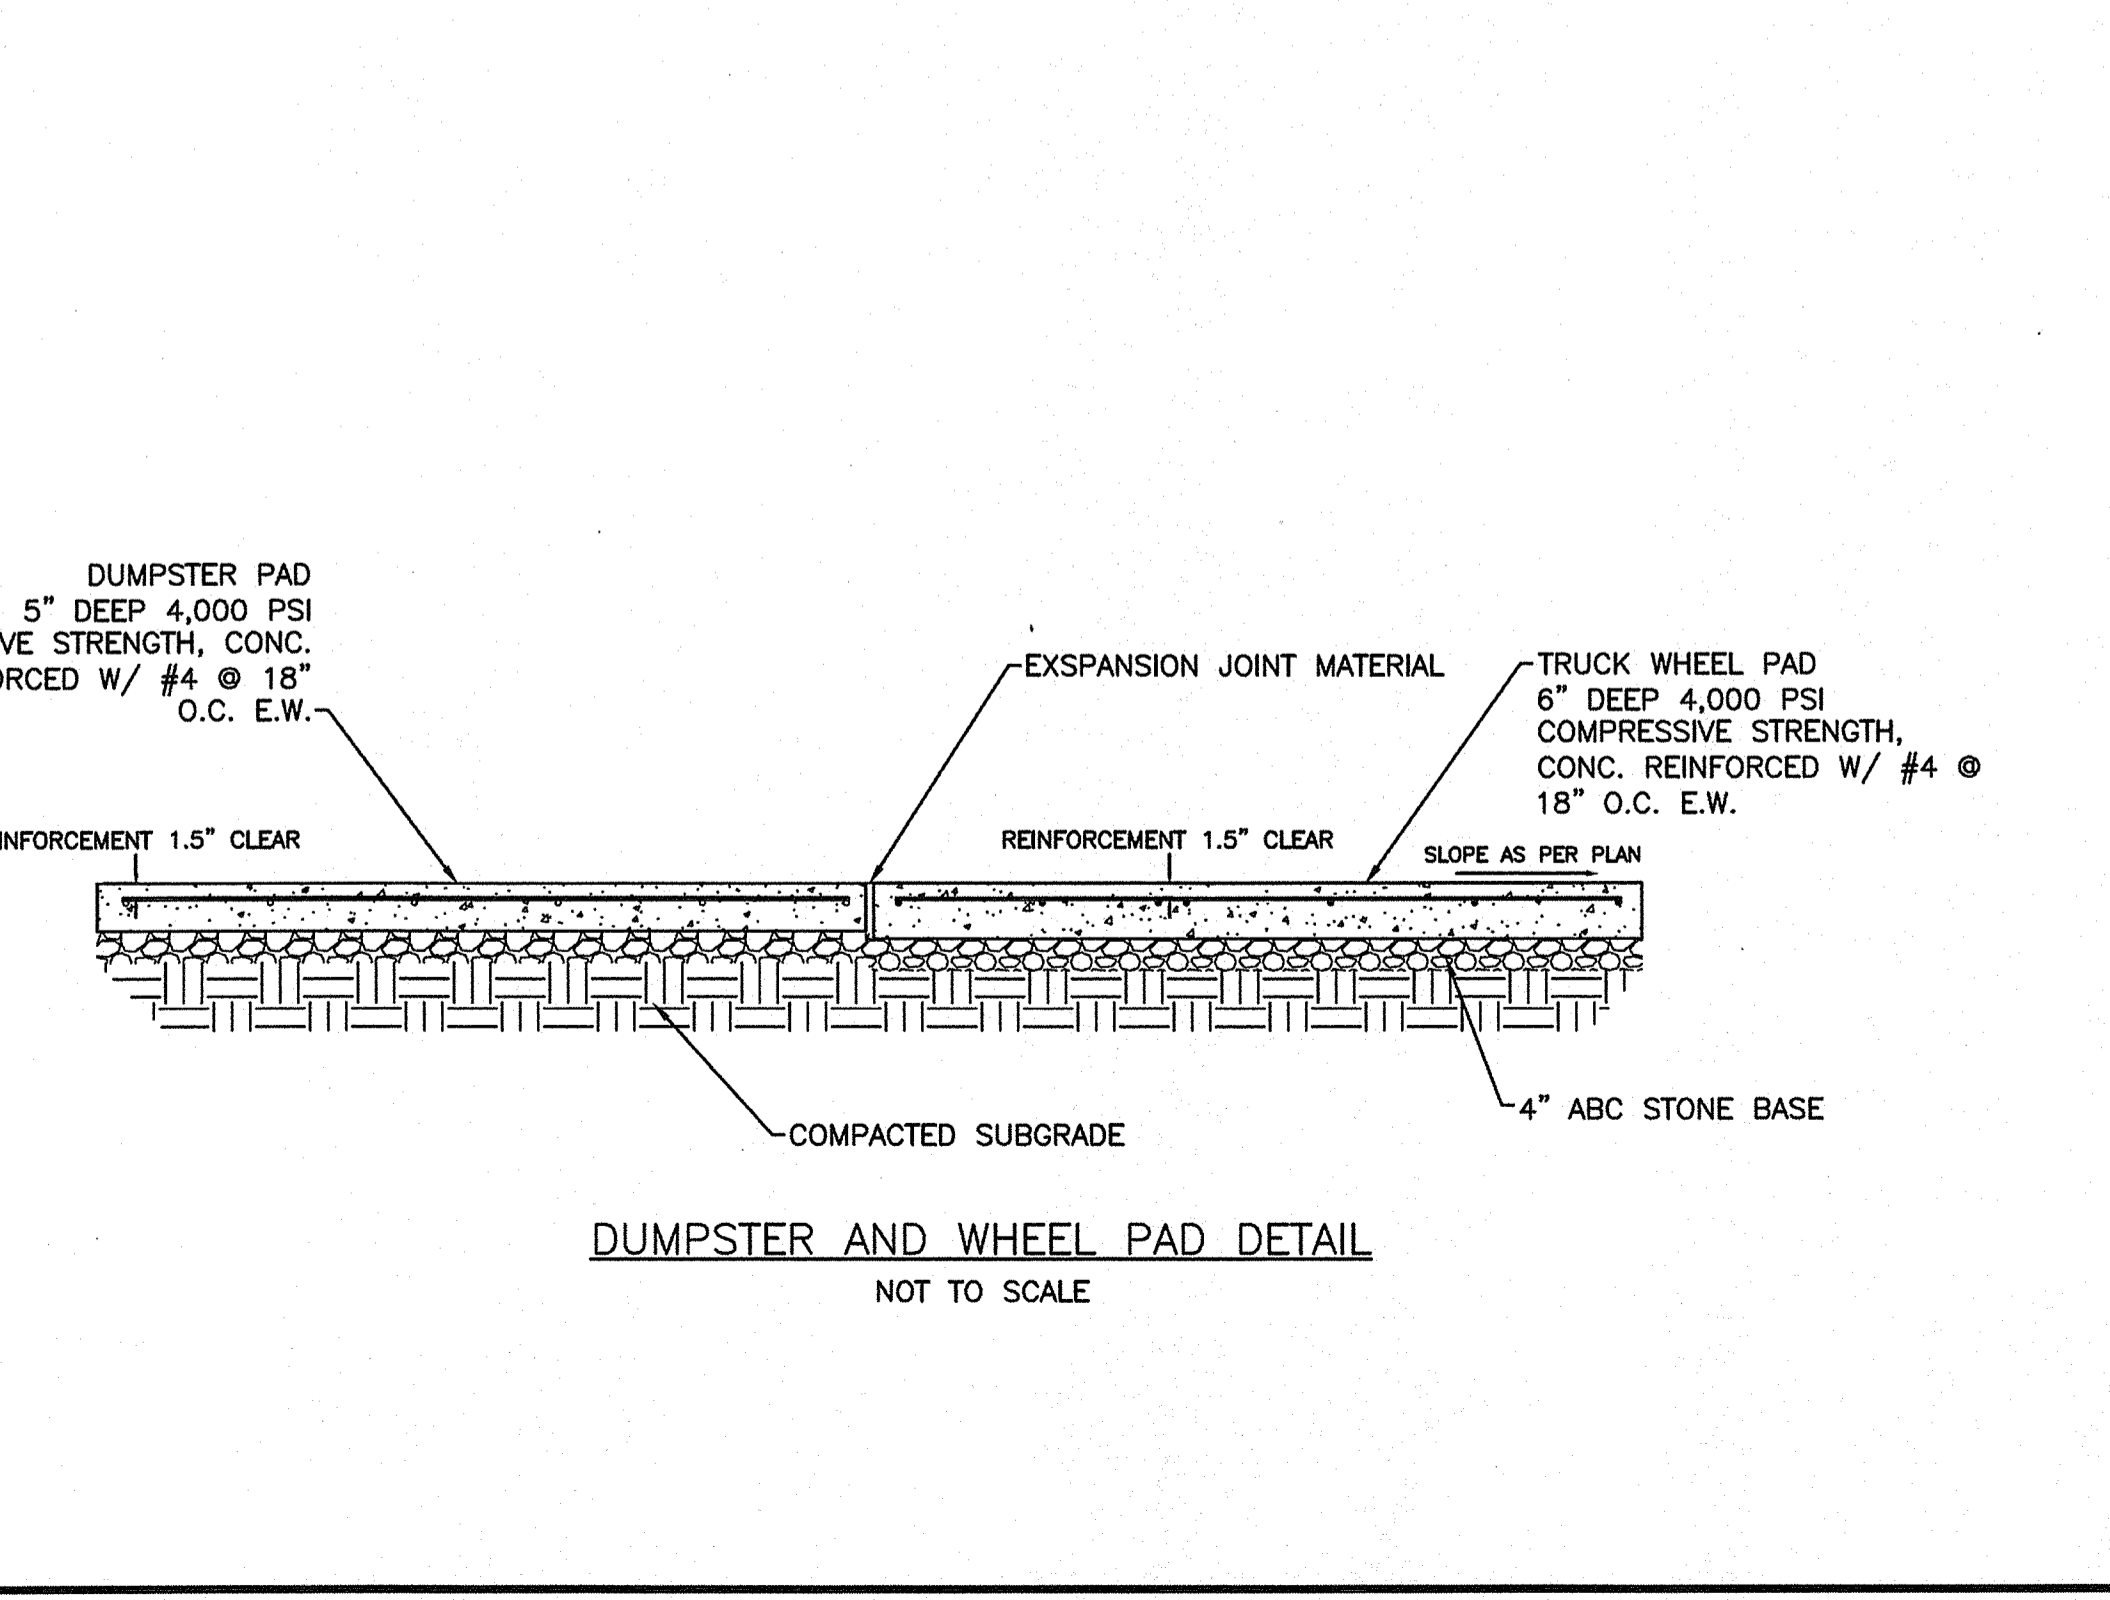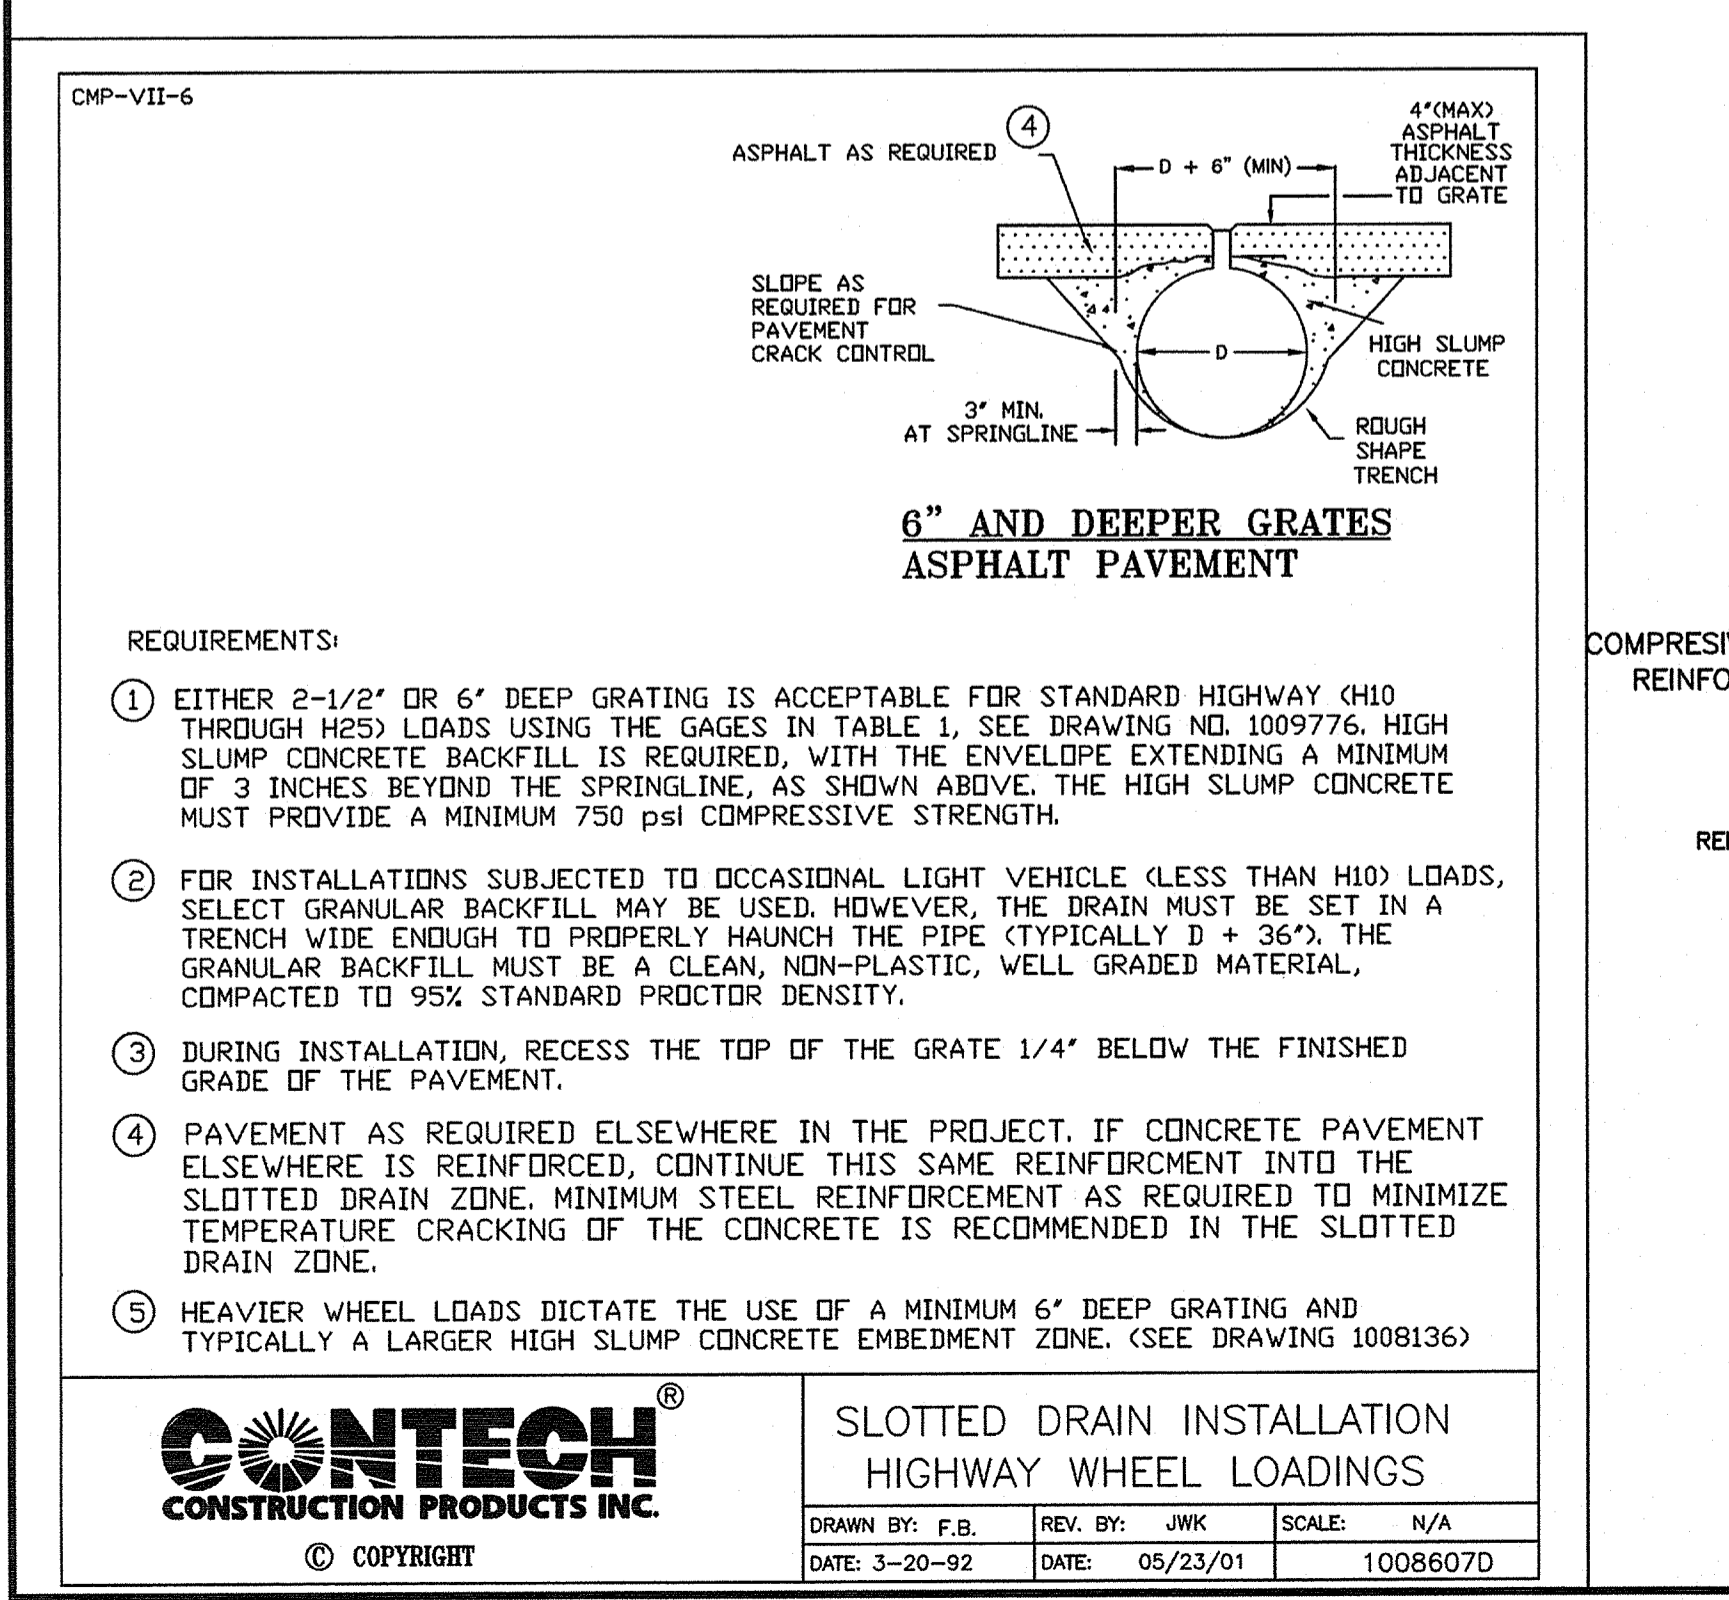

DUMPSTER PAD

PIPE BOLLARD (TYP)

WOOD GATE

WHEEL PAD

DUMPSTER SLAB PLAN

Approved Construction Plan

Name: *Nicole Smith* Date: *1/30/20*

Planning: *Nicole Smith*

Traffic: *W. McDonald* 1-30-20

Fire: *C. Webb* 1/30/20

CITY OF WILMINGTON NORTH CAROLINA
Public Services • Engineering Division
APPROVED STORMWATER MANAGEMENT PLAN

Date: *1/30/2020* Permit # *2020003*

Signed: *Josh Christensen*

For each open utility cut of City streets, a \$325 permit shall be required from the City prior to occupancy and/or project acceptance

OWNER/DEVELOPER/APPLICANT: STATE EMPLOYEES' CREDIT UNION

PROJECT: STATE EMPLOYEES' CREDIT UNION - WILMINGTON S 17th STREET BRANCH

ADDRESS: 119 N. SALISBURY STREET RALEIGH, NORTH CAROLINA 27603 PHONE: 919-839-5300

ADDRESS: 4355 S 17TH STREET WILMINGTON NC 28412

PROJECT MANAGER: MTA FIELD SURVEY DATE: 02/15/19

CHECKED BY: DM DRAWING DATE: 12/03/2019

DRAWN BY: KD JOB #: SE1819100

SHEET C-7.3

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1 GLENWOOD AVE, SUITE 600 RALEIGH, NC 27603 PHONE: 919.789.9977

11202 DAVID TAYLOR DR., SUITE 115 CHARLOTTE, NC 28262 PHONE: 704.714.4580

5030 NEW CENTRE DR., SUITE B WILMINGTON, NC 28403 PHONE: 910.523.5715

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811 Know what's below. Call before you dig. 3 working days before you dig. For the location of underground utilities.


NOTICE: THE LOCATION OF EXISTING UNDERGROUND UTILITIES ARE SHOWN ON THIS DRAWING FOR INFORMATION ONLY AND HAVE NOT BEEN INDEPENDENTLY VERIFIED BY THE OWNER OR HIS REPRESENTATIVE. THE CONTRACTOR SHALL DETERMINE THE EXACT LOCATION OF ALL EXISTING UTILITIES BEFORE COMMENCING WORK AND ACCEPTS THE RESPONSIBILITY FOR ANY AND ALL DAMAGES WHICH MAY BE OCCURRED BY THE CONTRACTOR FAILURE TO PROPERLY LOCATE AND PRESERVE ANY AND ALL UNDERGROUND UTILITIES.

PROFESSIONAL ENGINEER SEAL 21979 MARK MARCURI


SEPI ENGINEERING & CONSTRUCTION INC. SEAL C-2197 N.C.

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- NOTES:**
1. PROVIDE TURNING RADIUS SUFFICIENT TO ACCOMMODATE LARGE TRUCKS
 2. LOCATE ENTRANCES TO PROVIDE FOR UTILIZATION BY ALL CONSTRUCTION VEHICLES
 3. MUST BE MAINTAINED IN A CONDITION WHICH WILL PREVENT TRACKING OR DIRECT FLOW OF MUD ONTO THE STREETS. PERIODIC TOP DRESSING WITH STONE WILL BE NECESSARY.
 4. ANY MATERIAL TRACKED ONTO THE ROADWAY MUST BE CLEANED UP IMMEDIATELY.
 5. LOCATE ALL GRAVEL CONSTRUCTION ENTRANCES AT ALL POINT TO SCALE OF INGRESS AND EGRESS UNTIL SITE IS STABILIZED. PROVIDE FREQUENT CHECKS OF THE DEVICE AND TIMELY MAINTENANCE.
 6. NUMBER AND LOCATION OF CONSTRUCTION ENTRANCES TO BE DETERMINED BY THE ENGINEER.
 7. USE CLASS "A" STONE OR OTHER AGGREGATE APPROVED BY THE ENGINEER.
 8. INSTALL CONSTRUCTION ENTRANCES IN A WAY TO PREVENT VEHICLES FROM BYPASSING CONSTRUCTION ENTRANCE LEAVING PROJECT SITE.

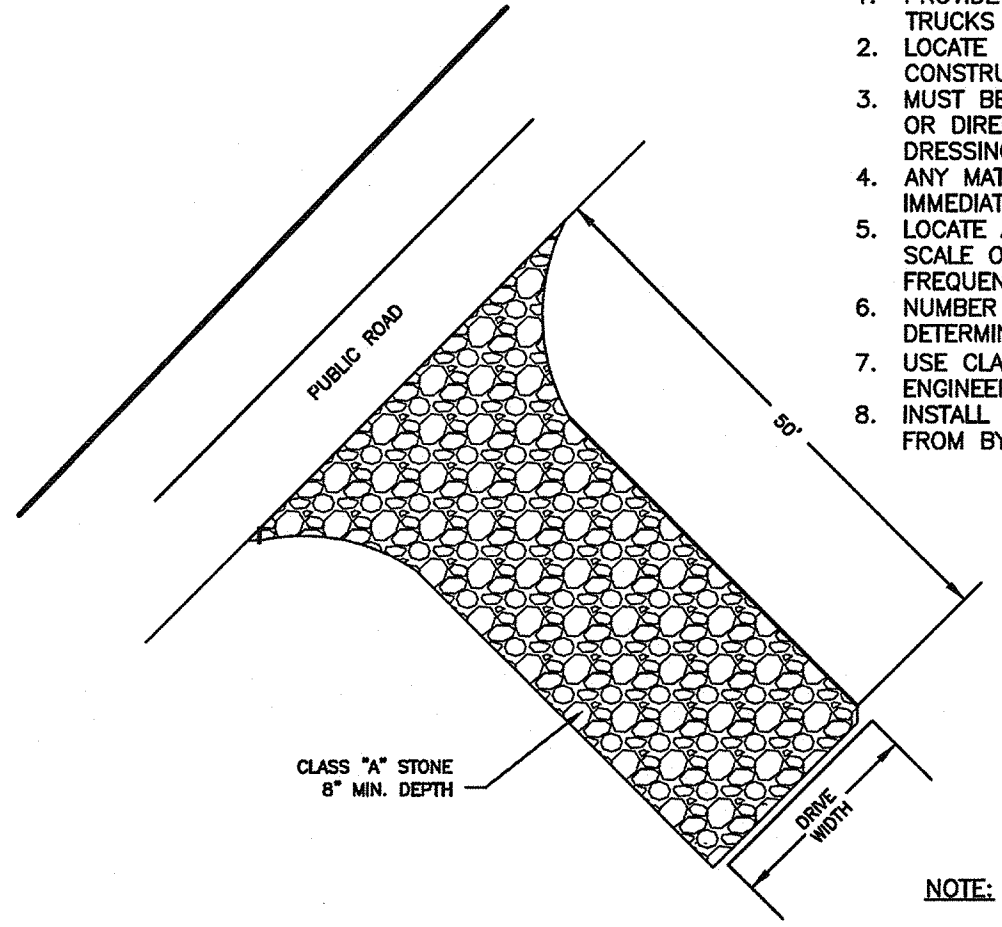


GRAVEL CONSTRUCTION ENTRANCE
NOT TO SCALE

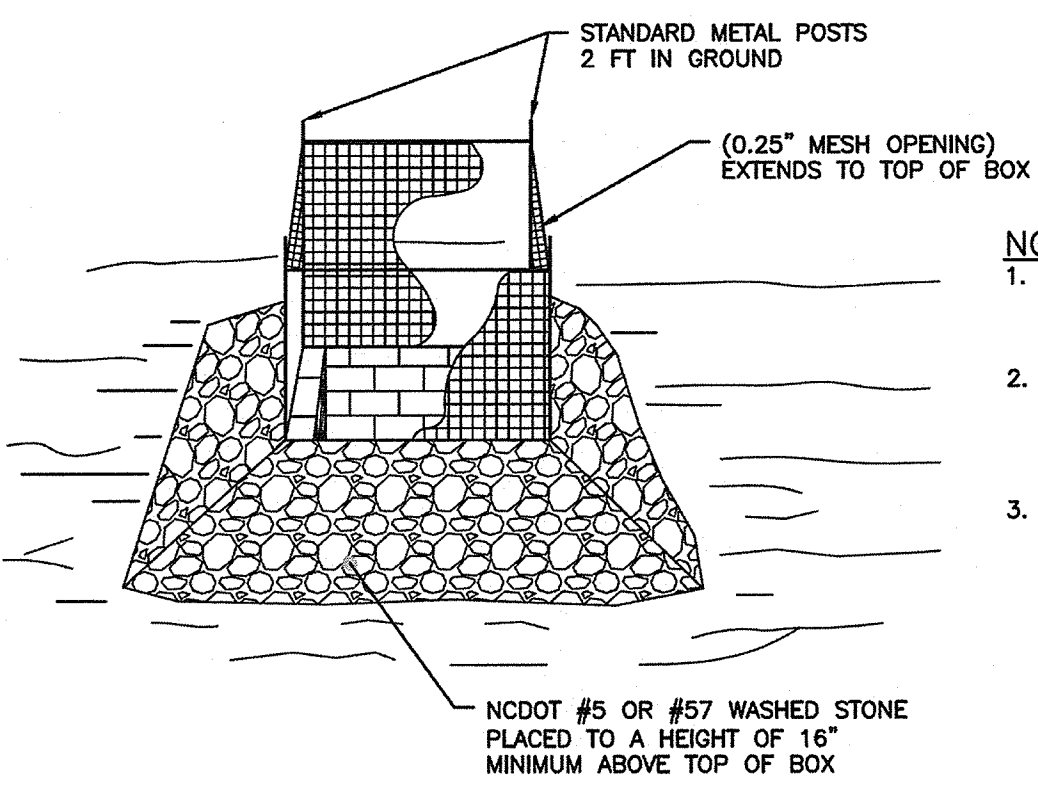

- NOTES:**
1. DRIVE 5-FOOT STEEL POSTS 2 FEET INTO THE GROUND SURROUNDING THE INLET. SPACE POSTS EVENLY AROUND THE PERIMETER OF THE INLET, A MAXIMUM OF 4 FEET APART.
 2. SURROUND THE POSTS WITH WIRE MESH HARDWARE CLOTH. SECURE THE WIRE MESH TO THE STEEL POSTS AT THE TOP, MIDDLE, AND BOTTOM. PLACING A 1-FOOT FLAP OF THE WIRE MESH UNDER THE GRAVEL FOR ANCHORING IS RECOMMENDED.
 3. PLACE CLEAN GRAVEL (NC DOT #5 OR #57 STONE) ON A 2:1 SLOPE WITH A MIN HEIGHT OF 16 INCHES AROUND THE WIRE, AND SMOOTH TO AN EVEN GRADE.

STANDARD INLET PROTECTION
NOT TO SCALE

- NOTE:**
THE CRITICAL ROOT ZONE (CRZ) OF A TREE IS WHERE THE MAJORITY OF A TREE'S ROOTS LAY. 85% OF MOST TREE ROOTS ARE FOUND IN THE TOP 24" OF THE SOIL AND SUPPLY THE MAJORITY OF NUTRIENTS AND WATER. GENERALLY, ROOTS SPREAD OUT 2-3X THE HEIGHT OF THE TREE.

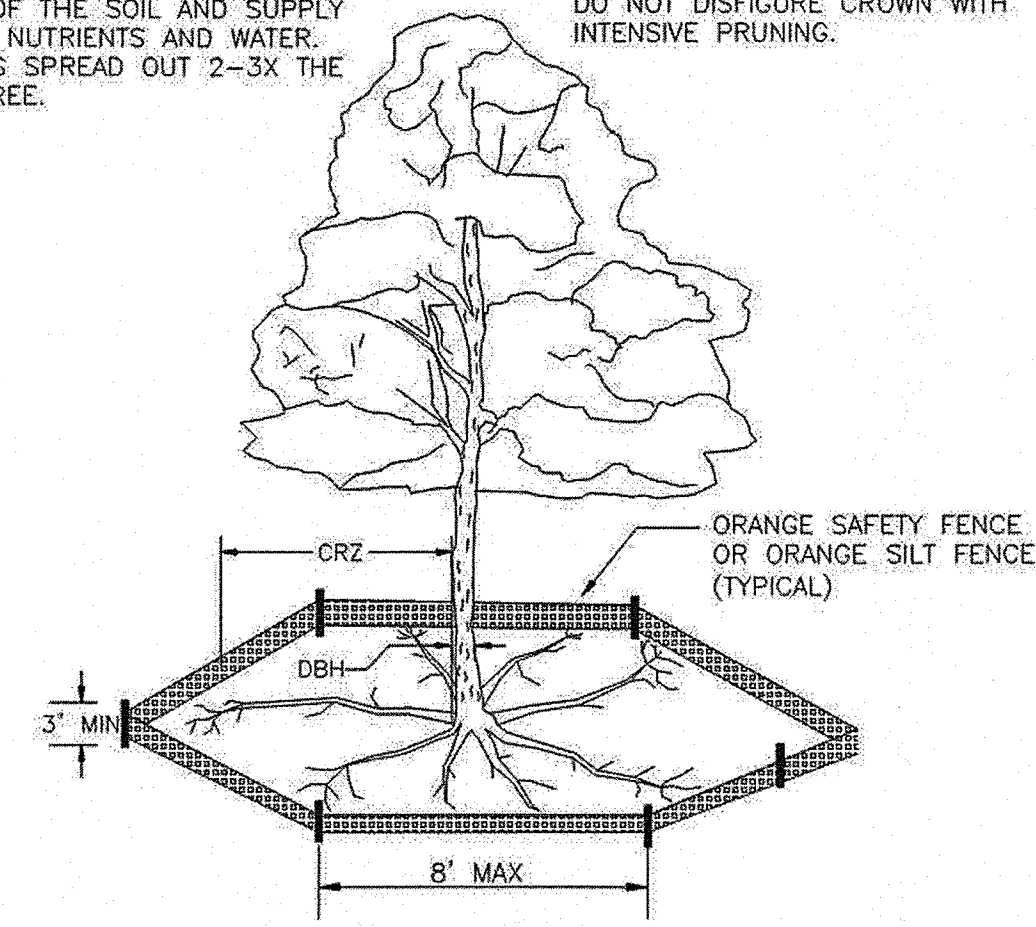

- NOTES:**
1. PROTECT CRITICAL ROOT ZONE (CRZ) OF TREES PRIOR TO CONSTRUCTION. CLEARLY MARK THE TREES AND ERECT A PROTECTIVE BARRIER AT THE CRZ. BARRIER SHALL BE MAINTAINED UNTIL CONSTRUCTION IS COMPLETE.
 2. CRZ RADIUS IS 1 FT PER INCH OF TREE DIAMETER AT BREST HEIGHT (DBH).
 3. IF CONSTRUCTION OCCURS WITHIN THE CRZ, AT LEAST 12" OF MULCH AND/OR LOGGING MATS SHALL BE PLACED WHERE MACHINERY MANUEVERS TO REDUCE SOIL COMPACTION IN THIS ZONE.
 4. WHERE SIDEWALKS AND PATHWAYS PASS WITHIN CRZ, EXTRA CARE SHALL BE TAKEN TO AVOID DAMAGE TO THE ROOTS. ALTERNATE CONSTRUCTION METHODS, SUCH AS A REINFORCED SIDEWALK, SHALL BE IMPLEMENTED AS NECESSARY.
 5. FOR ALL TREES, CUTTING OF LARGE STRUCTURAL ROOTS LOCATED NEAR THE BASE OF THE TRUNK IS PROHIBITED. DO NOT COMPACT SOIL BENEATH TREES. NO VEHICLE SHALL BE ALLOWED TO PARK UNDER TREES. NO MATERIALS OR EQUIPMENT SHALL BE STORED BENEATH TREES. DAMAGING THE BARK WITH LAWNMOWERS, CONSTRUCTION EQUIPMENT, OR ANYTHING ELSE IS PROHIBITED. CONTRACTOR SHALL REPAIR DAMAGE TO TREES.
 6. FAILING TO INSTALL OR MAINTAIN PROTECTION MEASURES SHALL RESULT IN A STOP WORK ORDER AND FINE OF \$500/DAY. DISTURBANCE OTHER THAN THAT ALLOWED ON THE APPROVED PLAN WILL REQUIRE OWNER TO POST A LETTER OF CREDIT FOR 3 YRS FOR TREE MITIGATION.

DATE: JAN, 2015
DRAWN BY: JSR
CHECKED BY: RDG, P.E.
SCALE: NOT TO SCALE

STANDARD DETAIL


TREE PROTECTION DURING CONSTRUCTION

SHEET 1 of 2

CITY OF WILMINGTON ENGINEERING
PO BOX 1810
WILMINGTON, NC 28402
(910) 341-7807

SD 15-09

- NOTE:**
CROWN OF THE TREE IS NEEDED FOR LEAF GROWTH TO PRODUCE OXYGEN, FILTER THE AIR, REDUCE WIND AND SOFTEN NOISE. DO NOT DISFIGURE CROWN WITH INTENSIVE PRUNING.

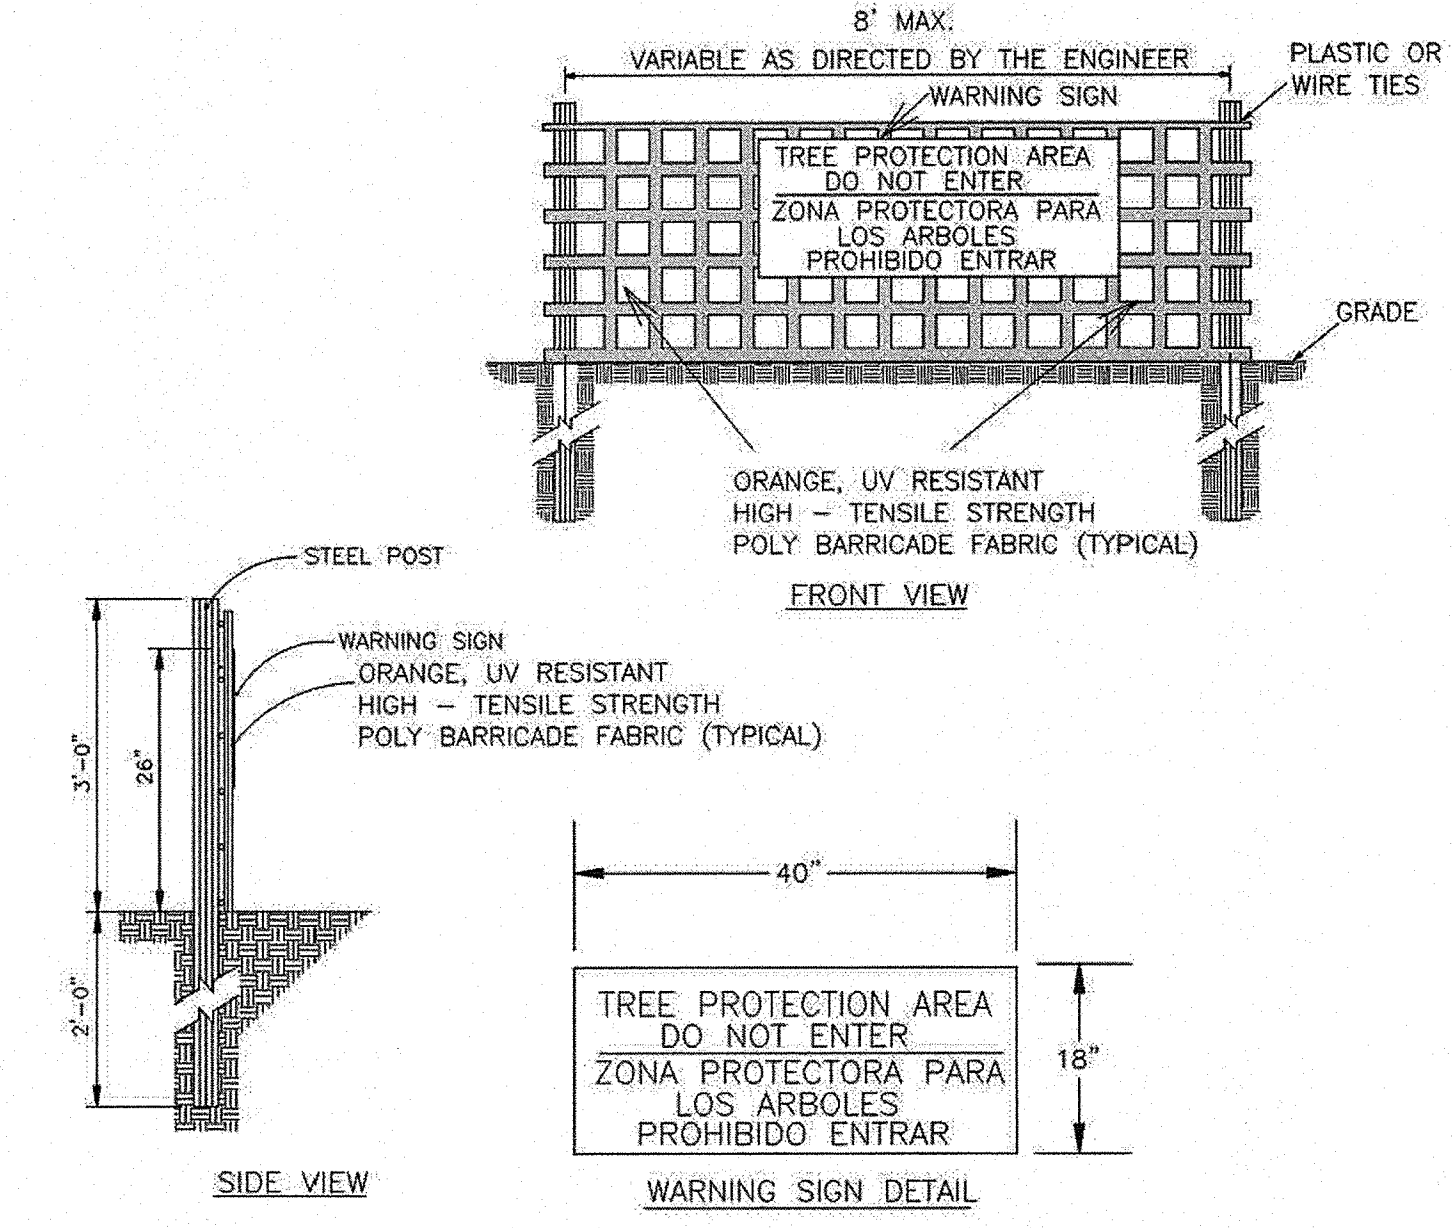

- NOTES:**
1. THE TREE PROTECTION FENCING SHALL NOT BE VIOLATED FOR THE ENTIRE DURATION OF THE PROJECT WITHOUT APPROVAL FROM URBAN FORESTRY STAFF.
 2. WARNING SIGNS TO BE MADE OF DURABLE, WEATHERPROOF MATERIAL. LETTERS TO BE 3" HIGH, MINIMUM, CLEARLY LEGIBLE AND SPACED AS DETAILED.
 3. SIGNS SHALL BE PLACED AT 50' MAXIMUM INTERVALS. PLACE A SIGN AT EACH END OF LINEAR TREE PROTECTION AND 50' ON CENTER THEREAFTER. FOR TREE PROTECTION AREAS LESS THAN 100' IN PERIMETER, PROVIDE NO LESS THAN TWO SIGNS PER PROTECTION AREA.
 4. ATTACH SIGNS SECURELY TO FENCE POSTS AND FABRIC. MAINTAIN TREE PROTECTION FENCE AND SIGNS THROUGHOUT DURATION OF PROJECT.
 5. TREE PROTECTION FENCING AND SIGNAGE SHALL BE REMOVED AFTER CONSTRUCTION.
 6. ADDITIONAL SIGNS MAY BE REQUIRED BY CITY OF WILMINGTON, BASED ON ACTUAL FIELD CONDITIONS.

DATE: JAN, 2015
DRAWN BY: JSR
CHECKED BY: RDG, P.E.
SCALE: NOT TO SCALE


STANDARD DETAIL

TREE PROTECTION DURING CONSTRUCTION

SHEET 2 of 2

CITY OF WILMINGTON ENGINEERING
PO BOX 1810
WILMINGTON, NC 28402
(910) 341-7807

SD 15-09

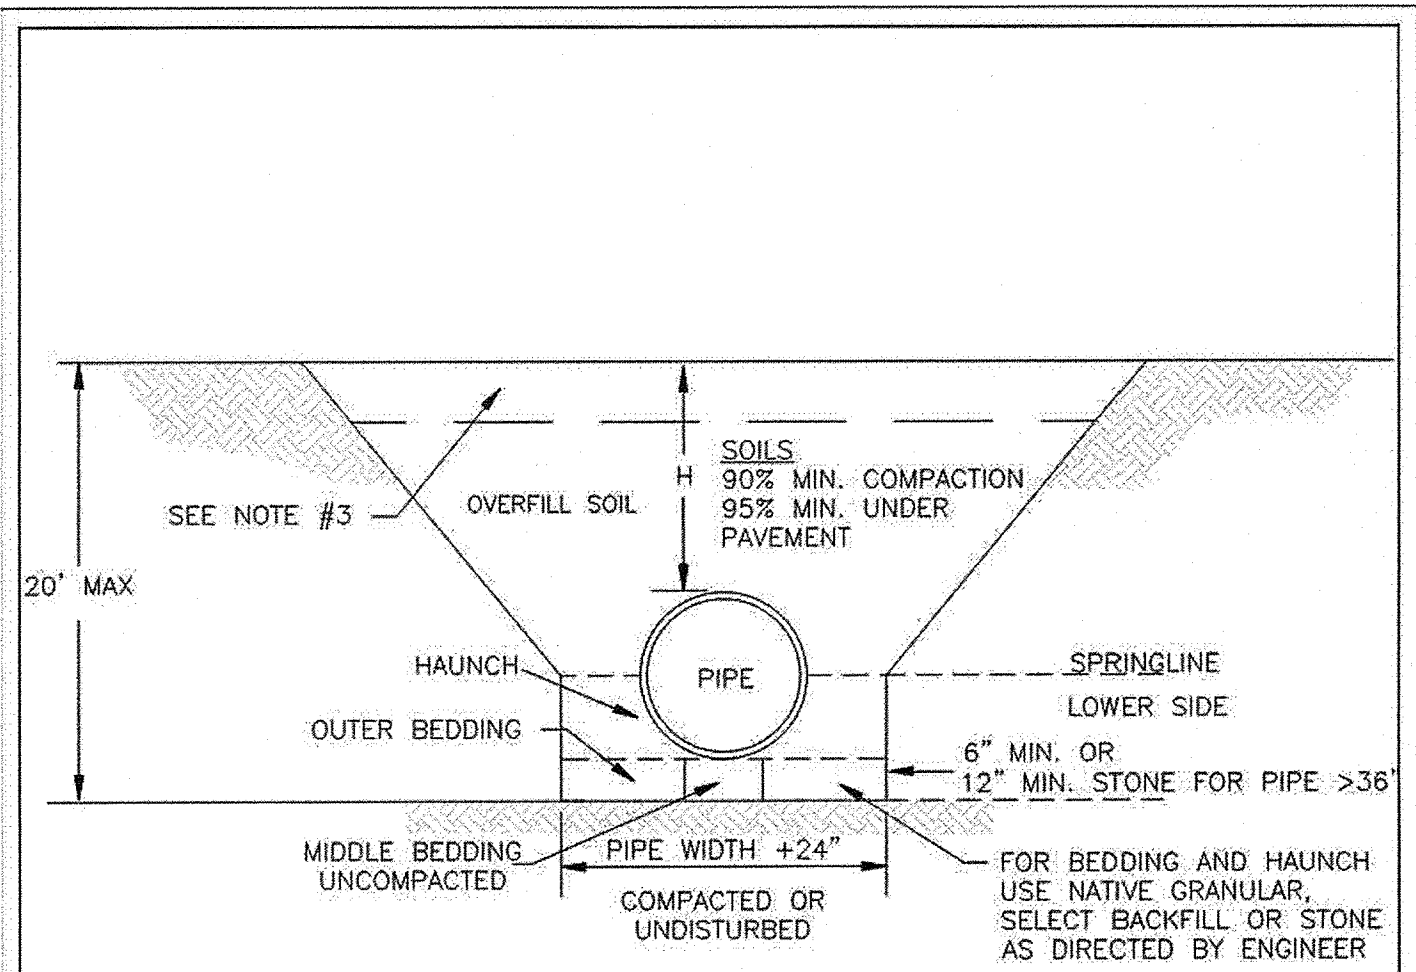

- NOTES:**
1. CONTRACTOR SHALL ENSURE BOTTOM OF TRENCH IS SUITABLE FOR PIPE INSTALLATION AND DOES NOT REQUIRE FOUNDATION CONDITIONING STONE.
 2. CONTRACTOR TO INSTALL BEDDING AND PIPE BEFORE INSTALLING HAUNCH AND THEN OVERFILL. SOILS SHALL BE INSTALLED IN 6"-8" LIFTS AND COMPACTED TO MIN. % DENSITY AS DETERMINED BY THE STANDARD PROCTOR ASTM D-698-A METHOD.
 3. WHERE IN PAVEMENT, CONTRACTOR SHALL ADHERE TO CITY STREET CUT POLICY AND SD 1-04 OR SD 1-05 FOR ROAD AND PAVEMENT REBUILD.
 4. SOIL SHALL BE COMPACTED BY A MECHANIZED TAMP (I.E. JUMPING JACK). HOWEVER, VIBRATORY ROLLERS > 18" WIDTH MAY BE USED FOR LARGER EXCAVATIONS. THE PLATE TAMP METHOD SHALL NOT BE USED.
 5. THIS DETAIL IS REPRESENTATIVE AND PIPE TRENCH DESIGN IS SUBJECT TO SPECIFIC SOIL CATEGORY (I, II, III), AND INSTALLATION TYPE (1, 2, 3, 4), AS DIRECTED BY THE ENGINEER AND SITE CONDITIONS.


DATE: MAY, 2013
DRAWN: JSR
CHECKED: BDR, P.E.
SCALE: NOT TO SCALE

STANDARD DETAIL

PIPE TRENCH TYPICAL

CITY OF WILMINGTON ENGINEERING OFFICE
212 OPERATIONS CENTER DRIVE
WILMINGTON, N.C. 28411
(910) 341-7807

SD 1-07

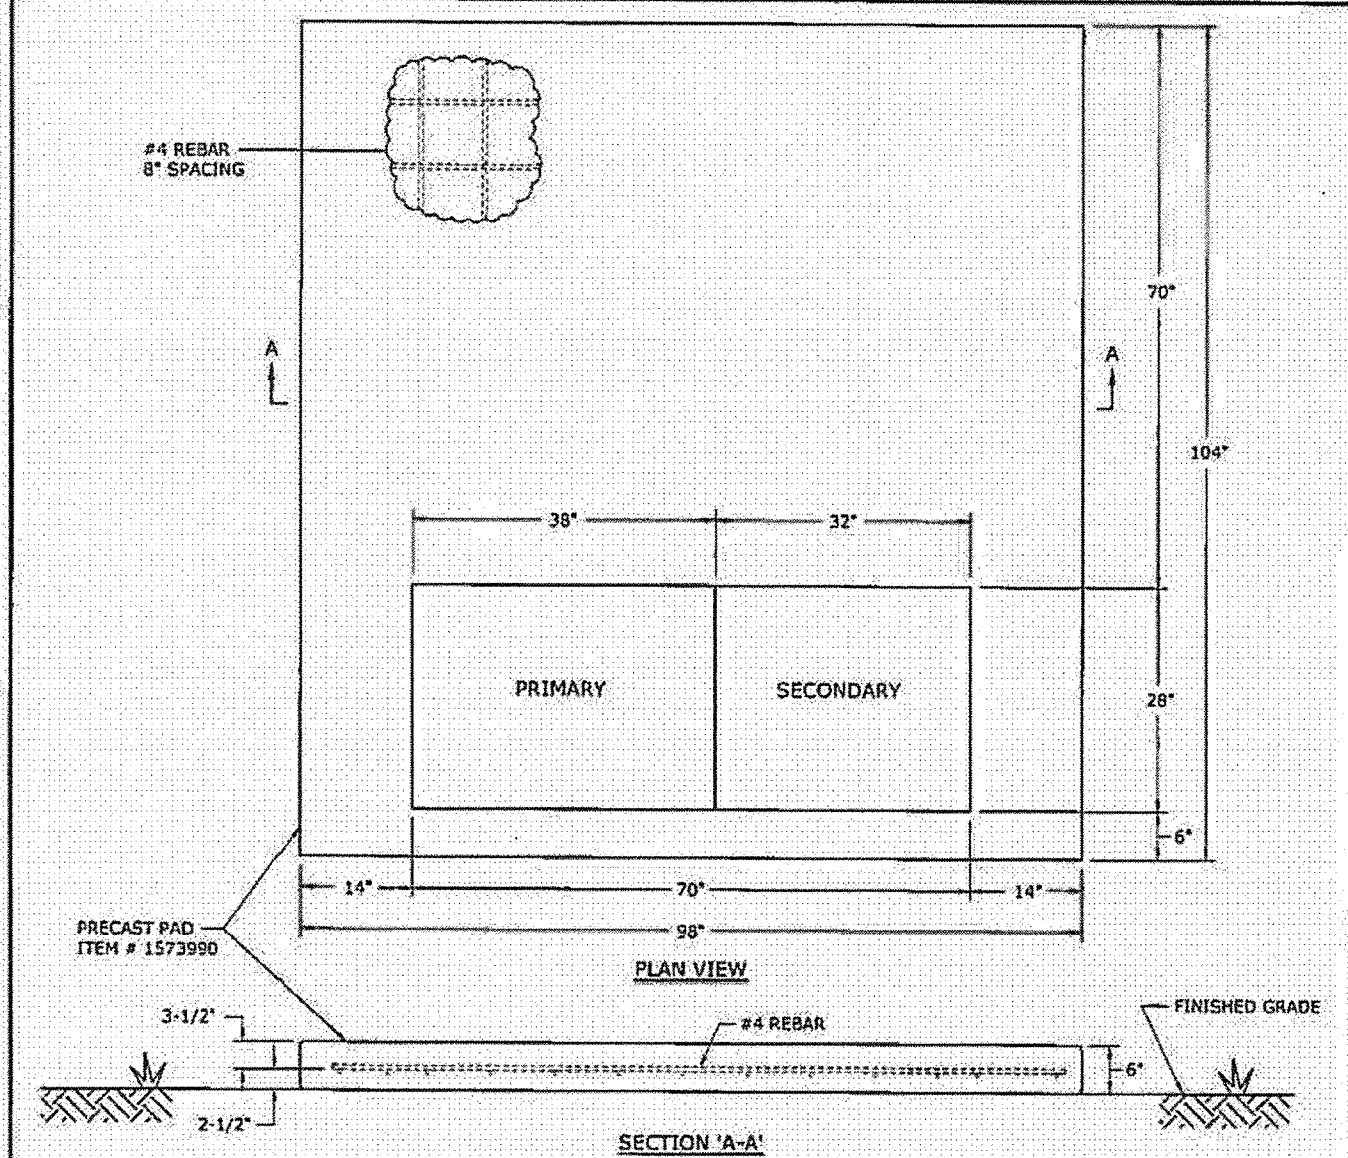



- NOTES:**
1. THIS STANDARD APPLIES TO THE DEF REGION, AND THE COASTAL AREAS IN THE DEF REGION.
 2. THE COMPANY RESERVES THE RIGHT TO REFUSE SERVICE TO NEW INSTALLATIONS THAT DO NOT MEET DUKE ENERGY REQUIREMENTS.
 3. REFERENCE DWG. 24-01-102 TO DETERMINE IF CURBING AND ABSORPTION BED IS REQUIRED.
 4. PROTECTIVE POLES ARE REQUIRED WHEN TRANSFORMERS ARE EXPOSED TO VEHICLE TRAFFIC. SEE DWG. 36-01-105 FOR PROTECTIVE POLE DETAILS.
 5. THERE SHALL BE MINIMUM CLEARANCES OF 10' IN FRONT OF THE TRANSFORMER AND 3' ON ALL OTHER SIDES OF THE TRANSFORMER. SEE DWGS. 36-01-101 AND 36-01-103 FOR MORE DETAILS ON CLEARANCES.
 6. TRANSFORMER MUST BE LOCATED IN AN AREA THAT ALLOWS SAFE ACCESS BY DUKE ENERGY CONSTRUCTION AND MAINTENANCE EQUIPMENT IN WET OR DRY WEATHER.
 7. CONSIDER FROST ACTION, DRAINAGE, AND LOCAL SOIL CONDITIONS WHEN PREPARING SITE FOR PAD. SOIL UNDERNEATH PADS SHALL BE LEVELED AND COMPACTED. SOIL SHALL ALSO BE FREE OF ROOTS AND OTHER ORGANIC MATERIALS TO PREVENT SETTLING AND EROSION. SOD MAY BE REQUIRED AROUND PAD TO PREVENT SOIL EROSION.
 8. USE FIRE ANT CONTROL IN PAD OPENINGS.
 9. ALL CONDUITS SHALL BE CUT SO THAT THE TOP OF THE CONDUIT IS FLUSH WITH THE TOP OF THE PAD.
 10. CUSTOMER SHALL INSTALL THE CONDUIT FOR THE PRIMARY CONDUCTORS AS CLOSE TO THE CENTER OF THE PRIMARY AREA AS PRACTICAL. THE SECONDARY CONDUITS SHALL BE INSTALLED TO THE RIGHT INSIDE THE SECONDARY AREA. SEE SERVICE GUIDE FOR PAD INSTALLATION DETAILS AND SPECIFICATIONS.
 11. OTHER UTILITIES SHALL NOT BE INSTALLED UNDER TRANSFORMER PAD. SEE SECTION 36 FOR MINIMUM CABLE CLEARANCES.
 12. SEE SECTION 27 OF THIS MANUAL FOR GROUND ROD AND GROUND BUS DETAILS.

REVISED BY: []
DATE: []


FLAT PADS FOR THREE-PHASE PAD-MOUNTED TRANSFORMERS
500 KVA - 5000 KVA

DEC 24 2011

DUKE ENERGY

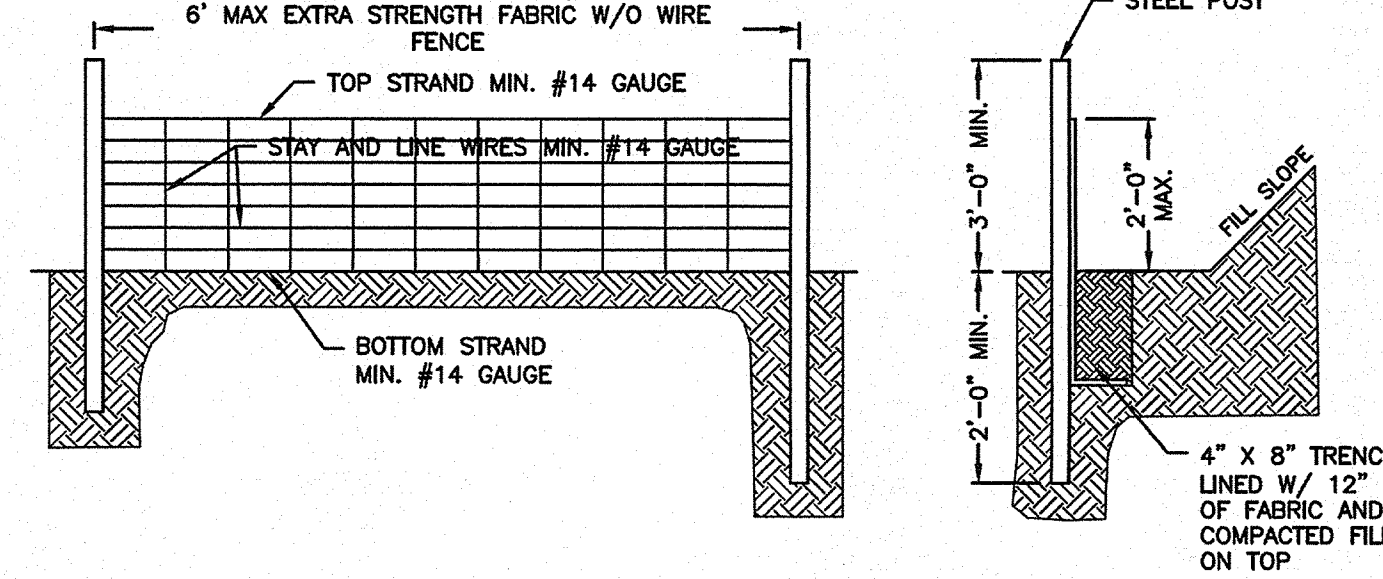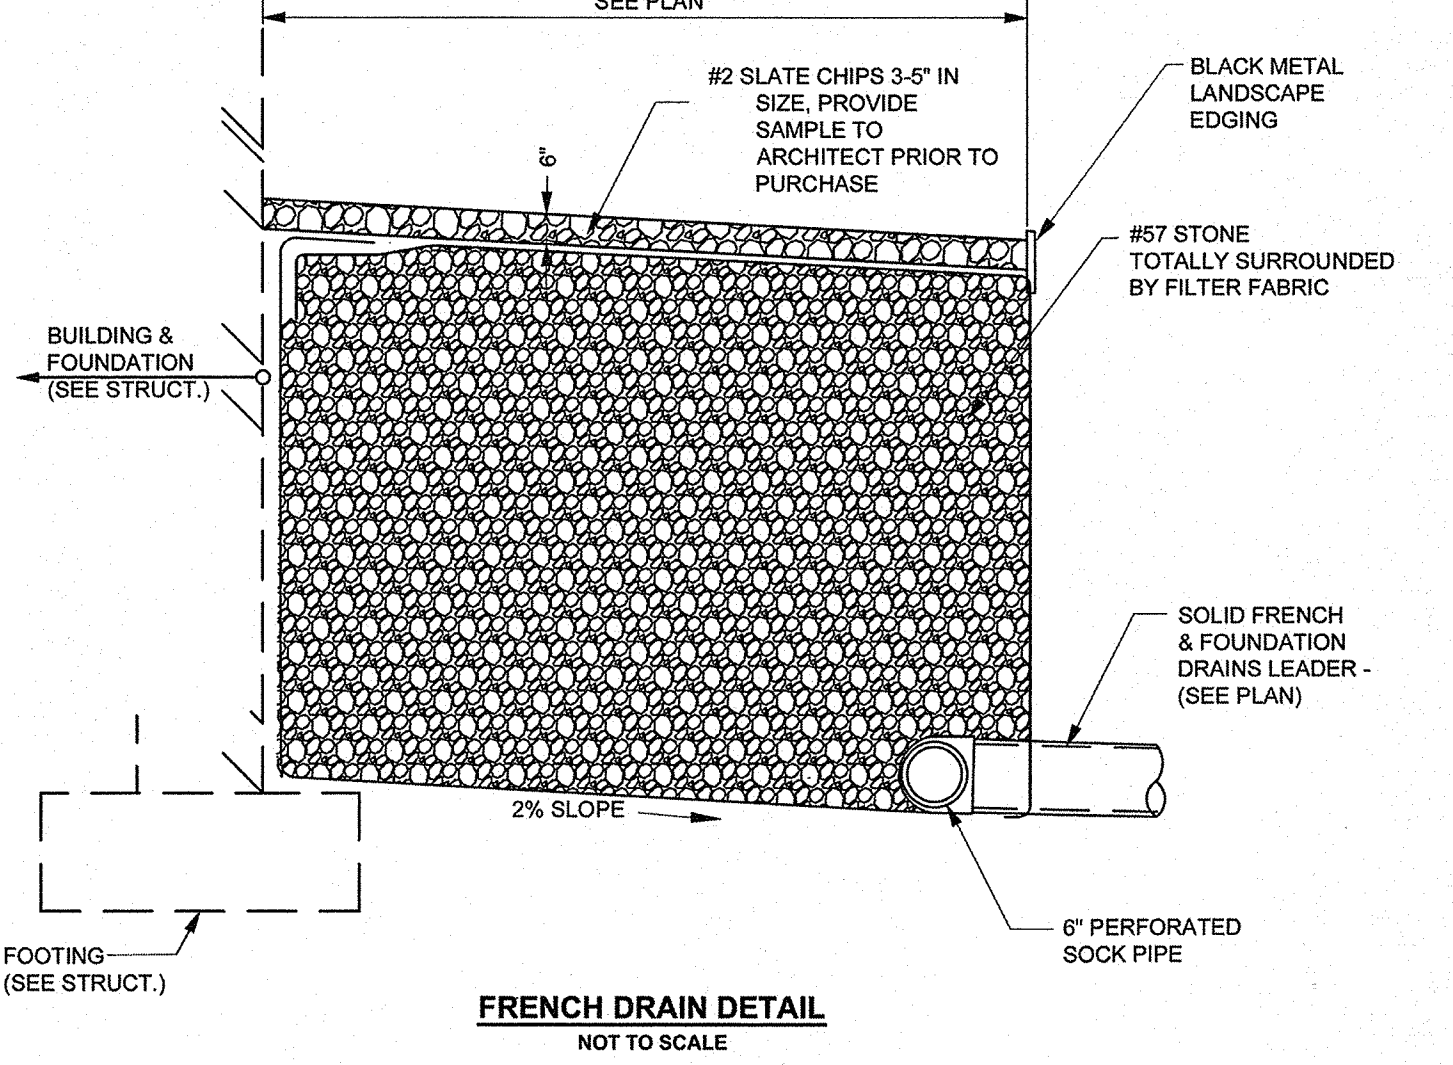

- NOTES:**
1. WIRE FENCE (IF USED) SHALL BE MINIMUM 14 GAUGE WITH A MAXIMUM MESH OPENING OF 6-INCHES.
 2. SYNTHETIC FILTER FABRIC OF AT LEAST 95% BY WEIGHT OF POLYOLEFIN'S OR POLYESTER, WHICH IS CERTIFIED BY THE MANUFACTURER OR SUPPLIER AS CONFORMING TO THE REQUIREMENTS IN ASTM D 6461 AND ALSO SHOULD CONTAIN ULTRAVIOLET RAY INHIBITORS AND STABILIZERS ACCORDING TO ASTM D 4355.
 3. SEE THE NC EROSION CONTROL MANUAL FOR SPECIFICATIONS INSTALLING SEDIMENT FENCE USING THE SLICING METHOD MACHINERY.

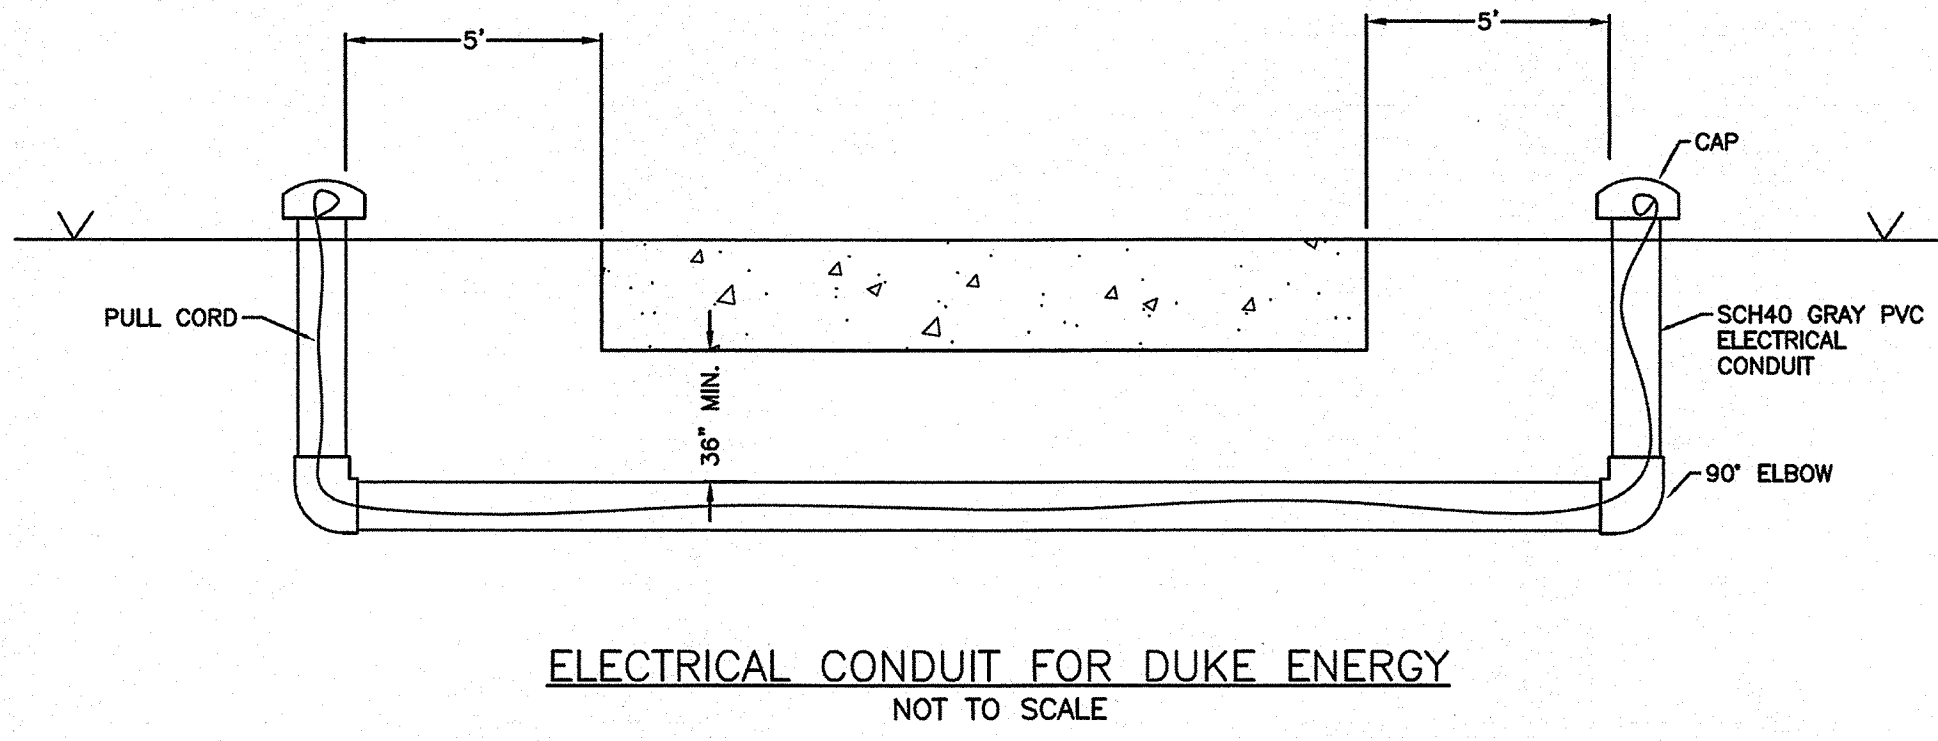

Approved Construction Plan

Name: Nicole Smyth
Date: 1/30/20

Planning: [Signature]
Traffic: [Signature]
Fire: [Signature]

Permit # 192003

CITY OF WILMINGTON NORTH CAROLINA
Public Services • Engineering Division
APPROVED STORMWATER MANAGEMENT PLAN

Date: 1/30/2020 Permit # 192003

Signed: [Signature]

For each open utility cut of City streets, a \$325 permit shall be required from the City prior to occupancy and/or project acceptance

SEPI

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PHONE 919.789.9977

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CHARLOTTE, NC 28262
PHONE 704.714.4880

5030 NEW CENTRE DR., SUITE B
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811

Know what's below.
Call before you dig.
3 WORKING DAYS BEFORE YOU DIG
FOR THE LOCATION OF UNDERGROUND UTILITIES

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NOTICE:
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NORTH CAROLINA PROFESSIONAL SEAL
MARK T. ARCURI
2020

CORPORATE SEAL
C-2197
N.C.

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OWNER/DEVELOPER/APPLICANT
STATE EMPLOYEES' CREDIT UNION

ADDRESS:
119 N. SALISBURY STREET
RALEIGH, NORTH CAROLINA 27603
PHONE: 919-839-5300

PROJECT
STATE EMPLOYEES' CREDIT UNION - WILMINGTON S 17TH STREET BRANCH

ADDRESS:
4355 S 17TH STREET
WILMINGTON NC 28412

PROJECT MANAGER
MTA

FIELD SURVEY DATE:
02/15/19

CHECKED BY: DM
DATE: 12/03/2019

DRAWN BY: KD
JOB #: SE18,19,100

SHEET
C-7.4

GROUND STABILIZATION AND MATERIALS HANDLING PRACTICES FOR COMPLIANCE WITH THE NCG01 CONSTRUCTION GENERAL PERMIT

Implementing the details and specifications on this plan sheet will result in the construction activity being considered compliant with the Ground Stabilization and Materials Handling sections of the NCG01 Construction General Permit (Sections E and F, respectively). The permittee shall comply with the Erosion and Sediment Control plan approved by the delegated authority having jurisdiction. All details and specifications shown on this sheet may not apply depending on site conditions and the delegated authority having jurisdiction.

Temporary and Permanent Groundcover*

STABILIZATION TIMEFRAMES
(Effective Aug. 3, 2011)

SITE AREA DESCRIPTION	STABILIZATION	TIMEFRAME EXCEPTIONS
Perimeter dikes, swales, ditches, slopes	7 days	None
High Quality Water (HQW) Zones	7 days	None
Slopes steeper than 3:1	7 days	If slopes are 10' or less in length and are not steeper than 2:1, 14 days are allowed.
Slopes 3:1 or flatter	14 days	7 days for slopes greater than 50' in length.
All other areas with slopes flatter than 4:1	14 days	None, except for perimeters and HQW Zones.

*-For Falls Lake watershed, in disturbed areas where grading activities are incomplete, provide temporary groundcover no later than seven (7) days for slopes steeper than 3:1; ten (10) days for slopes equal to or flatter than 3:1; fourteen (14) days for areas with no slope.

GROUND STABILIZATION SPECIFICATION

Stabilize the ground sufficiently so that rain will not dislodge the soil. Use one of the techniques in the table below:

Temporary Stabilization	Permanent Stabilization
<ul style="list-style-type: none"> Temporary grass seed covered with straw or other mulches and tackifiers Hydroseeding Rolled erosion control products with or without temporary grass seed Appropriately applied straw or other mulch Plastic sheeting 	<ul style="list-style-type: none"> Permanent grass seed covered with straw or other mulches and tackifiers Geotextile fabrics such as permanent soil reinforcement matting Hydroseeding Shrubs or other permanent plantings covered with mulch Uniform and evenly distributed ground cover sufficient to restrain erosion Structural methods such as concrete, asphalt or retaining walls

POLYACRYLAMIDES (PAMS) AND FLOCCULANTS

- Select flocculants that are appropriate for the soils being exposed during construction, selecting from the *NC DWR List of Approved PAMS/Flocculants*.
- Apply flocculants at or before the inlets to Erosion and Sediment Control Measures.
- Apply flocculants at the concentrations specified in the *NC DWR List of Approved PAMS/Flocculants* and in accordance with the manufacturer's instructions.
- Provide ponding area for containment of treated Stormwater before discharging offsite.
- Store flocculants in leak-proof containers that are kept under storm-resistant cover or surrounded by secondary containment structures.



NCG01 GROUND STABILIZATION AND MATERIALS HANDLING

EFFECTIVE: 03/01/19

EQUIPMENT AND VEHICLE MAINTENANCE

- Maintain vehicles and equipment to prevent discharge of fluids.
- Provide drip pans under any stored equipment.
- Identify leaks and repair as soon as feasible, or remove leaking equipment from the project.
- Collect all spent fluids, store in separate containers and properly dispose as hazardous waste (recycle when possible).
- Remove leaking vehicles and construction equipment from service until the problem has been corrected.
- Bring used fuels, lubricants, coolants, hydraulic fluids and other petroleum products to a recycling or disposal center that handles these materials.

LITTER, BUILDING MATERIAL AND LAND CLEARING WASTE

- Never bury or burn waste. Place litter and debris in approved waste containers.
- Provide a sufficient number of waste containers on site to manage the quantity of waste produced.
- Locate waste containers at least 50 feet away from storm drain inlets and surface waters unless no other alternatives are reasonably available.
- Locate waste containers on areas that do not receive substantial amounts of runoff from upland areas and does not drain directly to a storm drain, stream or wetland.
- Cover waste containers at the end of each workday and before storm events. Repair or replace damaged waste containers.
- Anchor all lightweight items in waste containers during times of high winds.
- Empty waste containers as needed to prevent overflow.
- Dispose waste off-site at an approved disposal facility.

PAINT AND OTHER LIQUID WASTE


- Do not dump paint and other liquid waste into storm drains, streams or wetlands.
- Locate paint washouts at least 50 feet away from storm drain inlets and surface waters unless no other alternatives are reasonably available.
- Contain liquid wastes in a controlled area.
- Containment must be labeled, sized and placed appropriately for the needs of site.
- Prevent the discharge of soaps, solvents, detergents and other liquid wastes from construction sites.

PORTABLE TOILETS

- Install portable toilets on level ground, at least 50 feet away from storm drains, streams or wetlands unless there is no alternative reasonably available. If 50 foot offset is not attainable, provide relocation of portable toilet behind silt fence or place on a gravel pad and surround with sand bags.
- Provide staking or anchoring of portable toilets during periods of high winds or in high foot traffic areas.
- Monitor portable toilets for leaking and properly dispose of any leaked material. Utilize a licensed sanitary waste hauler to remove leaking portable toilets and replace with properly operating unit.

EARTHEN STOCKPILE MANAGEMENT

- Show stockpile locations on plans. Locate earthen-material stockpile areas at least 50 feet away from storm drain inlets, sediment basins, perimeter sediment controls and surface waters unless it can be shown no other alternatives are reasonably available.
- Protect stockpile with silt fence installed along toe of slope with a minimum offset of five feet from the toe of stockpile.
- Provide stable stone access point when feasible.
- Stabilize stockpile within the timeframes provided on this sheet and in accordance with the approved plan and any additional requirements. Soil stabilization is defined as vegetative, physical or chemical coverage techniques that will restrain accelerated erosion on disturbed soils for temporary or permanent control needs.

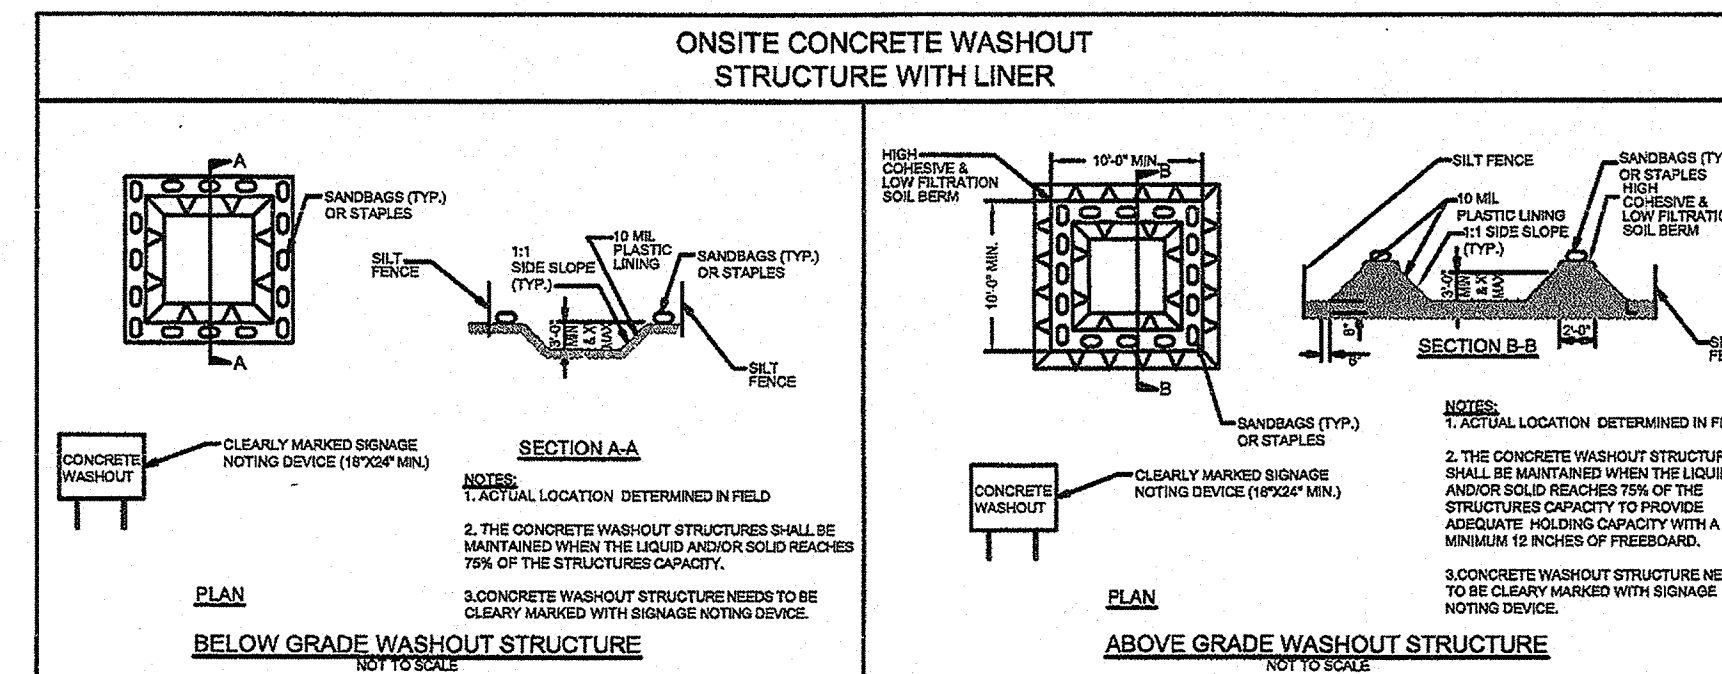

CONCRETE WASHOUTS

- Do not discharge concrete or cement slurry from the site.
- Dispose of, or recycle settled, hardened concrete residue in accordance with local and state solid waste regulations and at an approved facility.
- Manage washout from mortar mixers in accordance with the above item and in addition place the mixer and associated materials on impervious barrier and within lot perimeter silt fence.
- Install temporary concrete washouts per local requirements, where applicable. If an alternate method or product is to be used, contact your approval authority for review and approval. If local standard details are not available, use one of the two types of temporary concrete washouts provided on this detail.
- Do not use concrete washouts for dewatering or storing defective curb or sidewalk sections. Stormwater accumulated within the washout may not be pumped into or discharged to the storm drain system or receiving surface waters. Liquid waste must be pumped out and removed from project.
- Locate washouts at least 50 feet from storm drain inlets and surface waters unless it can be shown that no other alternatives are reasonably available. At a minimum, install protection of storm drain inlet(s) closest to the washout which could receive spills or overflow.
- Locate washouts in an easily accessible area, on level ground and install a stone entrance pad in front of the washout. Additional controls may be required by the approving authority.
- Install at least one sign directing concrete trucks to the washout within the project limits. Post signage on the washout itself to identify this location.
- Remove leavings from the washout when at approximately 75% capacity to limit overflow events. Replace the tarp, sand bags or other temporary structural components when no longer functional. When utilizing alternative or proprietary products, follow manufacturer's instructions.
- At the completion of the concrete work, remove remaining leavings and dispose of in an approved disposal facility. Fill pit, if applicable, and stabilize any disturbance caused by removal of washout.

HERBICIDES, PESTICIDES AND RODENTICIDES

- Store and apply herbicides, pesticides and rodenticides in accordance with label restrictions.
- Store herbicides, pesticides and rodenticides in their original containers with the label, which lists directions for use, ingredients and first aid steps in case of accidental poisoning.
- Do not store herbicides, pesticides and rodenticides in areas where flooding is possible or where they may spill or leak into wells, stormwater drains, ground water or surface water. If a spill occurs, clean area immediately.
- Do not stockpile these materials onsite.

HAZARDOUS AND TOXIC WASTE

- Create designated hazardous waste collection areas on-site.
- Place hazardous waste containers under cover or in secondary containment.
- Do not store hazardous chemicals, drums or bagged materials directly on the ground.



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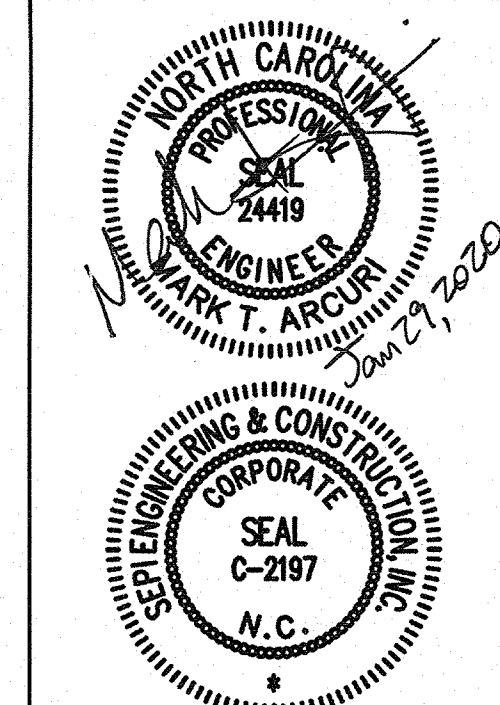
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Know what's below.
Call before you dig.
3 WORKING DAYS
BEFORE YOU DIG
FOR THE LOCATION OF
UNDERGROUND FACILITIES

THE LOCATION OF EXISTING UNDERGROUND UTILITIES ARE SHOWN ON APPROVED PLANS AND ARE NOT BEING INDICATED BY THE OWNER OR ITS REPRESENTATIVE. THE CONTRACTOR SHALL DETERMINE THE EXACT LOCATION OF ALL EXISTING UTILITIES BEFORE COMMENCING WORK AND ASSUME TO BE FULLY RESPONSIBLE FOR ANY AND ALL DAMAGES WHICH MAY BE OCCURRED BY THE CONTRACTOR'S FAILURE TO EXACTLY LOCATE AND PRESERVE ANY AND ALL UNDERGROUND UTILITIES.

NOTICE:
CONSTRUCTION SITE SAFETY IS THE SOLE RESPONSIBILITY OF THE CONTRACTOR. WITHIN THE OWNER AND THE ENGINEER SHALL BE EXPECTED TO ASSURE ANY RESPONSIBILITY FOR SAFETY OF THE WORK. ALL PERSONS ENGAGED IN THE WORK OF ANY NEARBY STRUCTURES, OR OF ANY OTHER PERSONS.



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OWNER/DEVELOPER/APPLICANT:
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119 N. SALISBURY STREET
RALEIGH, NORTH CAROLINA 27603
PHONE: 919-639-5300

PROJECT:
STATE EMPLOYEES' CREDIT UNION - WILMINGTON S 17th STREET BRANCH
ADDRESS:
4355 S 17TH STREET
WILMINGTON NC 28412

PROJECT MANAGER:
MTA
CHECKED BY:
DM
DRAWN BY:
KD
FIELD SURVEY DATE:
02/15/19
DRAWING DATE:
12/03/2019
JOB #:
SE1819100
SHEET

Approved Construction Plan
Name: Nicole D Smith Date: 1/30/20
Planning: N Smith
Traffic: N Smith 1-30-20
Fire: C. Webb 1/31/20

CITY OF WILMINGTON
NORTH CAROLINA
Public Services • Engineering Division
APPROVED STORMWATER MANAGEMENT PLAN
Date: 1/30/2020 Permit # 2020003
Signed: [Signature]

For each open utility cut of City streets, a \$325 permit shall be required from the City prior to occupancy and/or project acceptance

**PART III
SELF-INSPECTION, RECORDKEEPING AND REPORTING**

SECTION A: SELF-INSPECTION

Self-inspections are required during normal business hours in accordance with the table below. When adverse weather or site conditions would cause the safety of the inspection personnel to be in jeopardy, the inspection may be delayed until the next business day on which it is safe to perform the inspection. In addition, when a storm event of greater than 1.0 inch occurs outside of normal business hours, the self-inspection shall be performed upon the commencement of the next business day. Any time when inspections were delayed shall be noted in the Inspection Record.

Inspect	Frequency (during normal business hours)	Inspection records must include [40 CFR 122.41]:
(1) Rain gauge maintained in good working order	Daily	Daily rainfall amounts. If no daily rain gauge observations are made during weekend or holiday periods, and no individual-day rainfall information is available, record the cumulative rain measurement for those un-attended days (and this will determine if a site inspection is needed). Days on which no rainfall occurred shall be recorded as "zero." The permittee may use another rain-monitoring device approved by the Division.
(2) E&SC Measures	At least once per 7 calendar days and within 24 hours of a rain event > 1.0 inch in 24 hours	1. Identification of the measures inspected, 2. Date and time of the inspection, 3. Name of the person performing the inspection, 4. Indication of whether the measures were operating properly, 5. Description of maintenance needs for the measure, 6. Corrective actions taken, and 7. Date of actions taken.
(3) Stormwater discharge outfalls (SDOs)	At least once per 7 calendar days and within 24 hours of a rain event > 1.0 inch in 24 hours	1. Identification of the discharge outfalls inspected, 2. Date and time of the inspection, 3. Name of the person performing the inspection, 4. Evidence of indicators of stormwater pollution such as oil sheen, floating or suspended solids or discoloration, 5. Indication of visible sediment leaving the site, 6. Actions taken to correct/prevent sedimentation, and 7. Date of actions taken.
(4) Perimeter of site	At least once per 7 calendar days and within 24 hours of a rain event > 1.0 inch in 24 hours	If visible sedimentation is found outside site limits, then a record of the following shall be made: 1. Actions taken to clean up or stabilize the sediment that has left the site limits, 2. Date of actions taken, and 3. An explanation as to the actions taken to control future releases.
(5) Streams or wetlands onsite or offsite (where accessible)	At least once per 7 calendar days and within 24 hours of a rain event > 1.0 inch in 24 hours	If the stream or wetland has increased visible sedimentation or a stream has visible increased turbidity from the construction activity, then a record of the following shall be made: 1. Evidence and actions taken to reduce sediment contributions, and 2. Records of the required reports to the appropriate Division Regional Office per Part III, Section C, Item (2)(a) of this permit of this permit.

NOTE: The rain inspection resets the required 7 calendar day inspection requirement.

**PART III
SELF-INSPECTION, RECORDKEEPING AND REPORTING**

SECTION B: RECORDKEEPING

1. E&SC Plan Documentation

The approved E&SC plan as well as any approved deviation shall be kept on the site. The approved E&SC plan must be kept up-to-date throughout the coverage under this permit. The following items pertaining to the E&SC plan shall be documented in the manner described:

Item to Document	Documentation Requirements
(a) Each E&SC Measure has been installed and does not significantly deviate from the locations, dimensions and relative elevations shown on the approved E&SC Plan.	Initial and date each E&SC Measure on a copy of the approved E&SC Plan or complete, date and sign an inspection report that lists each E&SC Measure shown on the approved E&SC Plan. This documentation is required upon the initial installation of the E&SC Measures or if the E&SC Measures are modified after initial installation.
(b) A phase of grading has been completed.	Initial and date a copy of the approved E&SC Plan or complete, date and sign an inspection report to indicate completion of the construction phase.
(c) Ground cover is located and installed in accordance with the approved E&SC Plan.	Initial and date a copy of the approved E&SC Plan or complete, date and sign an inspection report to indicate compliance with approved ground cover specifications.
(d) The maintenance and repair requirements for all E&SC Measures have been performed.	Complete, date and sign an inspection report.
(e) Corrective actions have been taken to E&SC Measures.	Initial and date a copy of the approved E&SC Plan or complete, date and sign an inspection report to indicate the completion of the corrective action.

2. Additional Documentation

In addition to the E&SC Plan documents above, the following items shall be kept on the site and available for agency inspectors at all times during normal business hours, unless the Division provides a site-specific exemption based on unique site conditions that make this requirement not practical:

- (a) This general permit as well as the certificate of coverage, after it is received.
- (b) Records of inspections made during the previous 30 days. The permittee shall record the required observations on the Inspection Record Form provided by the Division or a similar inspection form that includes all the required elements. Use of electronically-available records in lieu of the required paper copies will be allowed if shown to provide equal access and utility as the hard-copy records.
- (c) All data used to complete the Notice of Intent and older inspection records shall be maintained for a period of three years after project completion and made available upon request. [40 CFR 122.41]

**PART III
SELF-INSPECTION, RECORDKEEPING AND REPORTING**

SECTION C: REPORTING

1. Occurrences that must be reported

Permittees shall report the following occurrences:

- (a) Visible sediment deposition in a stream or wetland.
- (b) Oil spills if:
 - They are 25 gallons or more,
 - They are less than 25 gallons but cannot be cleaned up within 24 hours,
 - They cause sheen on surface waters (regardless of volume), or
 - They are within 100 feet of surface waters (regardless of volume).
- (a) Releases of hazardous substances in excess of reportable quantities under Section 311 of the Clean Water Act (Ref: 40 CFR 110.3 and 40 CFR 117.3) or Section 102 of CERCLA (Ref: 40 CFR 302.4) or G.S. 143-215.85.
- (b) Anticipated bypasses and unanticipated bypasses.
- (c) Noncompliance with the conditions of this permit that may endanger health or the environment.

2. Reporting Timeframes and Other Requirements

After a permittee becomes aware of an occurrence that must be reported, he shall contact the appropriate Division regional office within the timeframes and in accordance with the other requirements listed below. Occurrences outside normal business hours may also be reported to the Division's Emergency Response personnel at (800) 662-7956, (800) 858-0368 or (919) 733-3300.

Occurrence	Reporting Timeframes (After Discovery) and Other Requirements
(a) Visible sediment deposition in a stream or wetland	<ul style="list-style-type: none"> • Within 24 hours, an oral or electronic notification. • Within 7 calendar days, a report that contains a description of the sediment and actions taken to address the cause of the deposition. Division staff may waive the requirement for a written report on a case-by-case basis. • If the stream is named on the <u>NC 303(d) list</u> as impaired for sediment-related causes, the permittee may be required to perform additional monitoring, inspections or apply more stringent practices if staff determine that additional requirements are needed to assure compliance with the federal or state impaired-waters conditions.
(b) Oil spills and release of hazardous substances per Item 1(b)-(c) above	<ul style="list-style-type: none"> • Within 24 hours, an oral or electronic notification. The notification shall include information about the date, time, nature, volume and location of the spill or release.
(c) Anticipated bypasses [40 CFR 122.41(m)(3)]	<ul style="list-style-type: none"> • A report at least ten days before the date of the bypass, if possible. The report shall include an evaluation of the anticipated quality and effect of the bypass.
(d) Unanticipated bypasses [40 CFR 122.41(m)(3)]	<ul style="list-style-type: none"> • Within 24 hours, an oral or electronic notification. • Within 7 calendar days, a report that includes an evaluation of the quality and effect of the bypass.
(e) Noncompliance with the conditions of this permit that may endanger health or the environment [40 CFR 122.41(l)(7)]	<ul style="list-style-type: none"> • Within 24 hours, an oral or electronic notification. • Within 7 calendar days, a report that contains a description of the noncompliance, and its causes; the period of noncompliance, including exact dates and times, and if the noncompliance has not been corrected, the anticipated time noncompliance is expected to continue; and steps taken or planned to reduce, eliminate, and prevent reoccurrence of the noncompliance. [40 CFR 122.41(l)(6). • Division staff may waive the requirement for a written report on a case-by-case basis.




NCG01 SELF-INSPECTION, RECORDKEEPING AND REPORTING

EFFECTIVE: 03/01/19

Approved Construction Plan
 Name: Nicolet Smith Date: 1/30/20
 Planning: W. Emerson 1-30-20
 Traffic: C. White 1/30/20
 Fire: 1/30/20

City of Wilmington
 Public Services • Engineering Division
 APPROVED STORMWATER MANAGEMENT PLAN
 Date: 1/30/20 Permit # 2020003
 Signed: Kash Christian

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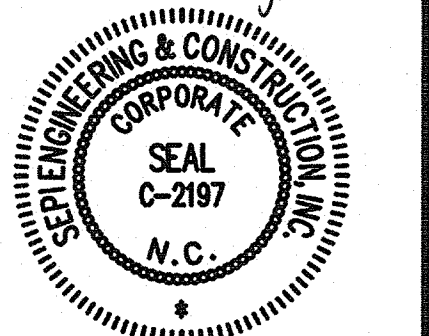
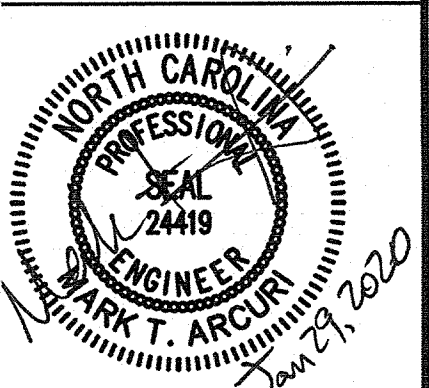
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 FOR THE LOCATION OF
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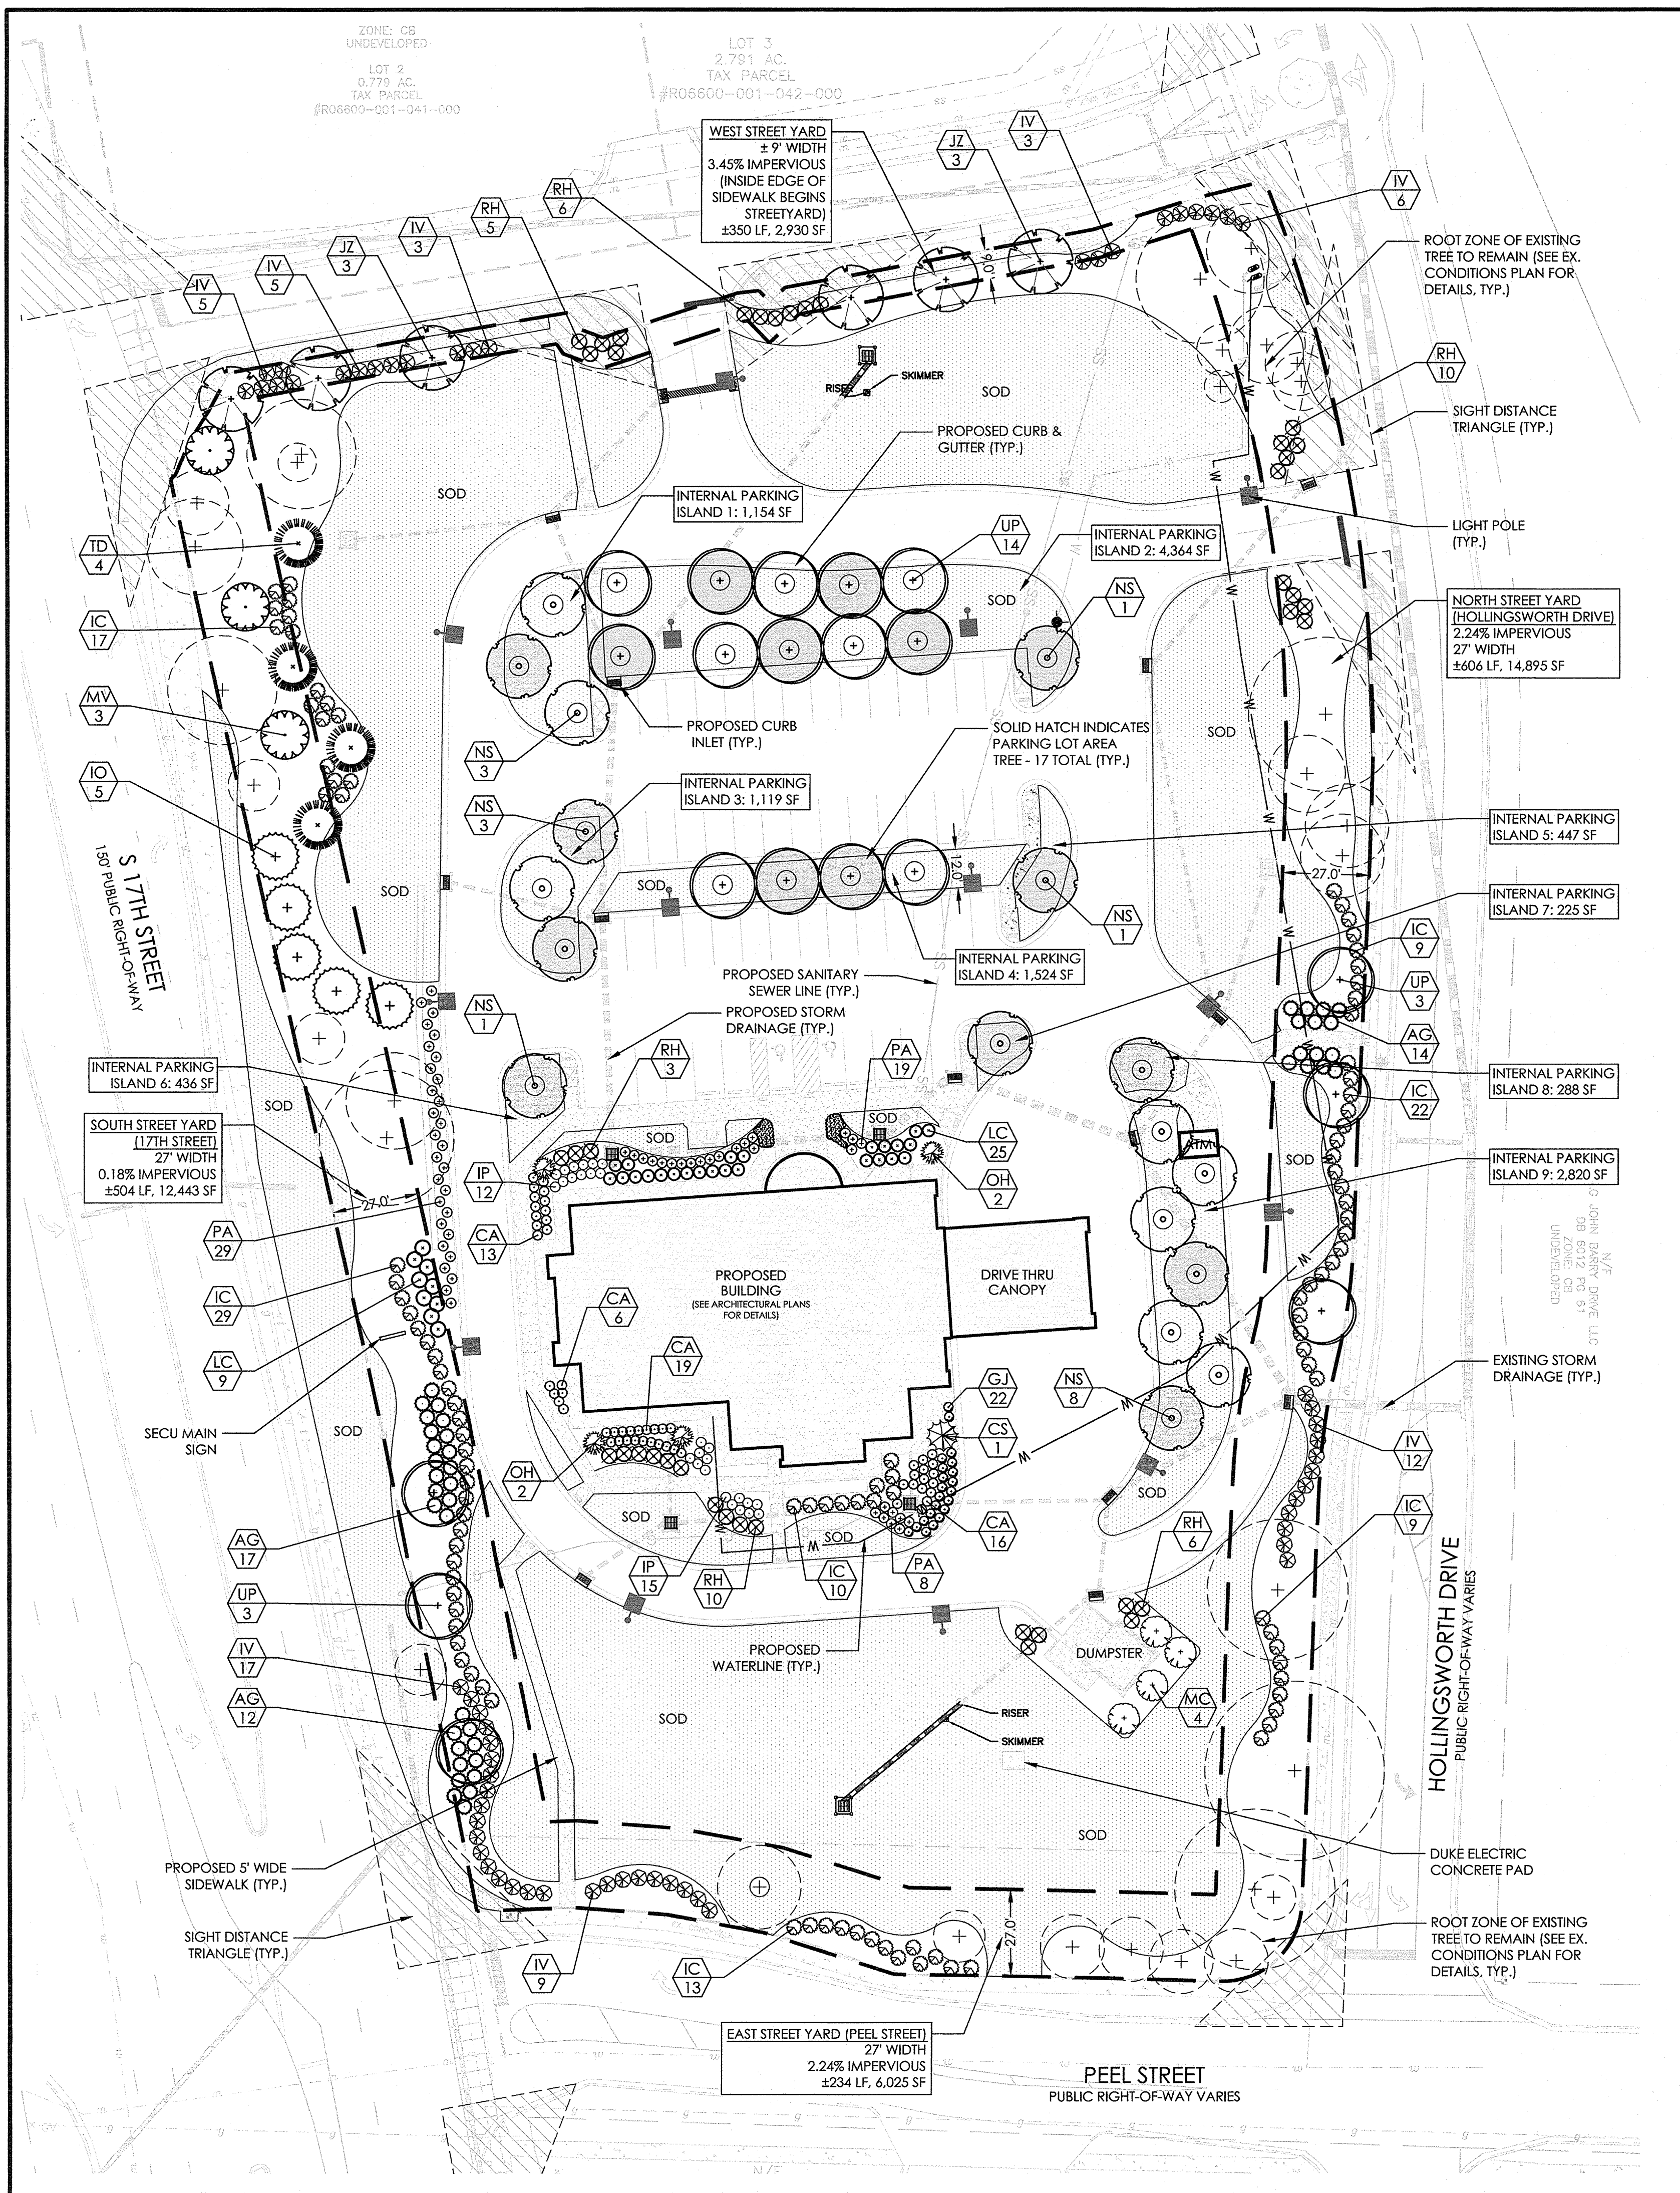
OWNER/DEVELOPER/APPLICANT
STATE EMPLOYEES' CREDIT UNION
 ADDRESS:
 119 N. SALISBURY STREET
 RALEIGH, NORTH CAROLINA 27603
 PHONE: 919-889-5300

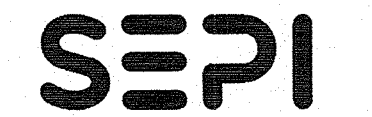PROJECT
STATE EMPLOYEES' CREDIT UNION - WILMINGTON S 17th STREET BRANCH
 ADDRESS:
 4355 S. 17TH STREET
 WILMINGTON NC 28412

PROJECT MANAGER
 MTA
 FIELD SURVEY DATE:
 02/15/19
 CHECKED BY:
 DM
 DRAWING DATE:
 12/03/2019
 DRAWN BY:
 JOB #:
 SE18.191.00


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NCG01 SELF-INSPECTION, RECORD KEEPING AND REPORTING




LANDSCAPE NOTES:

- ALL TECHNICAL SPECIFICATIONS AND GENERAL CONDITIONS APPLY. ALL GENERAL NOTES AND GENERAL CONSTRUCTION NOTES APPLY.
- THE CONTRACTOR IS RESPONSIBLE FOR ALL QUANTITY TAKE-OFFS AND VERIFICATION OF MATERIALS AS SHOWN ON THESE PLANS AND IN WRITTEN SPECIFICATIONS. THE CONTRACTOR SHALL NOTIFY THE LANDSCAPE ARCHITECT OF ANY DISCREPANCIES PRIOR TO FINAL BIDDING OR INSTALLATION.
- THE CONTRACTOR SHALL VERIFY LOCATIONS OF EXISTING AND PROPOSED UNDERGROUND UTILITIES PRIOR TO THE INSTALLATION OF ANY PLANT MATERIAL.
- ALL LANDSCAPE MATERIALS SHALL CONFORM TO THE ACCEPTED STANDARDS ESTABLISHED BY THE AMERICAN ASSOCIATION OF NURSERYMEN.
- PRIOR TO THE END OF EACH WORKING DAY, THE CONTRACTOR SHALL PROPERLY BACKFILL ALL PLANT MATERIAL THAT HAS BEEN PLACED IN PREPARED HOLES, AND PROPERLY WATER AND MULCH ALL PREPARED GROUNDCOVER, PERENNIAL AND ANNUAL BEDS.
- ALL TREES AND SHRUBS SHALL BE SOAKED WITH WATER AND MULCHED IMMEDIATELY FOLLOWING INSTALLATION.
- LANDSCAPE ARCHITECT OR OWNER SHALL APPROVE ANY ON-SITE PLANT STORAGE AREA.
- ALL ROOT BALLS REMOVED FROM CONTAINERS SHALL BE SCARIFIED BY HAND PRIOR TO PLACEMENT AND BACK FILLING WITH PREPARED SOILS. HAND TOOLS ARE NOT TO BE USED TO SCARIFY ROOT BALLS.
- ALL ROPE AND WRAPPING TWINE SHALL BE CUT AND REMOVED FROM AROUND THE UPPER PARTS OF THE ROOT BALL. METAL BASKET WIRES AND BURLAP SHALL BE PULLED BACK AND TUCKED UNDER THE EDGES OF THE SAUCER RINGS ON ALL TREES AND LARGE SHRUBS. ALL SYNTHETIC BURLAP SHALL BE REMOVED FROM PLANT BALLS PRIOR TO BACKFILLING.
- ALL PLANTING AREAS SHALL BE EDGED WITH SMOOTH, CONTINUOUS CURVES.
- ALL PLANT MATERIAL SHALL BE PLANTED AT HEIGHTS AS SPECIFIED IN THE PLANTING DETAILS & PLANT LIST. CONTAINER SIZES PROVIDED FOR REFERENCE ONLY.
- TREE STAKING AND GUYING, IF NECESSARY, SHALL BE PERFORMED WITHIN A WEEK OF PLANTING. THE LANDSCAPE CONTRACTOR SHALL BE RESPONSIBLE FOR REMOVING ALL TREE STAKING MATERIAL AFTER THE FIRST FULL GROWING SEASON OR ONE YEAR, WHICHEVER COMES FIRST.
- B & B AS LISTED UNDER "ROOT" IN THE PLANT LIST INDICATES BALLED AND BURLAPPED.
- ALL PLANT BEDS AND RAISED SAUCER RINGS SHALL BE GRADED TO PROVIDE ADEQUATE DRAINAGE AND SHALL BE MULCHED AS SPECIFIED.
- ALL MATERIALS, PLANTING AND LANDSCAPE WORK SHALL CONFORM TO THE LOCAL OR COUNTY JURISDICTIONAL AUTHORITIES' STANDARD SPECIFICATIONS AND DETAILS.
- ALL PROPOSED VEGETATION WITHIN SIGHT TRIANGLES SHALL NOT INTERFERE WITH CLEAR VISUAL SIGHT LINES FROM 30' - 10'.
- NO WETLANDS EXIST ON SITE PER USAGE JURISDICTION DETERMINATION ISSUED 4-9-2019 BY ACTION ID SAM-2012-00564.

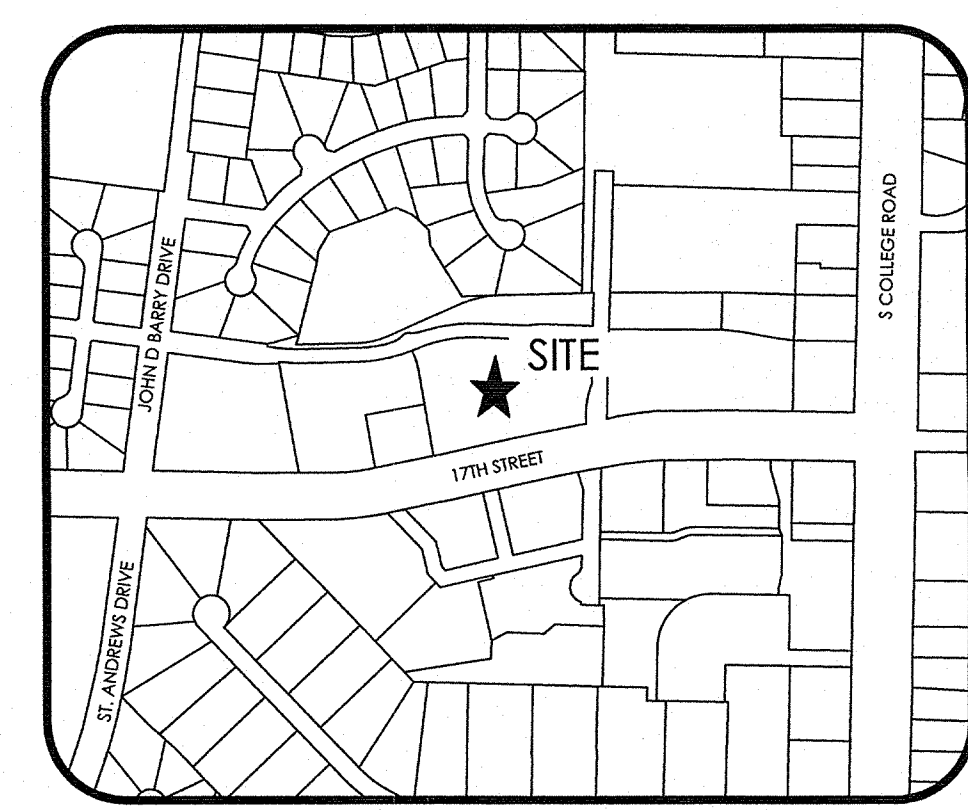

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TREES

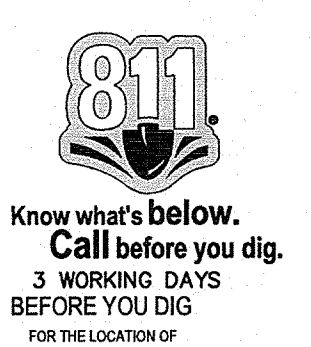QTY	SYM	BOTANICAL NAME	COMMON NAME	SIZE (min.)*	ROOT**	REMARKS
5	IO	<i>Ilex opaca</i>	American Holly	2" CAL.	B&B	
3	MV	<i>Magnolia virginiana</i>	Sweetbay Magnolia	2" CAL.	B&B	
18	NS	<i>Nyssa sylvatica</i>	Black Gum	2.5" CAL.	B&B	
4	TD	<i>Taxodium distichum</i>	Bald Cypress	2" CAL.	B&B	
20	UP	<i>Ulmus parvifolia</i>	Lacebark Elm	3" CAL.	B&B	
6	JZ	<i>Zelkova serrata</i>	Japanese Zelkova	2.5" CAL.	B&B	

SHRUBS, SMALL TREES, AND GRASSES

43	AG	<i>Abelia grandiflora 'Edward Goucher'</i>	Edward Goucher Abelia	24" HT.	3 GAL.	
54	CA	<i>Calamagrostis x acutiflora 'Karl Foerster'</i>	Feather Reed Grass	18" HT.	3 GAL.	
1	CS	<i>Camelia sasanqua</i>	Camelia	30" HT.	5 GAL.	
22	GJ	<i>Gardenia jasminoides 'Radicans'</i>	Dwarf Gardenia	18" HT.	3 GAL.	
109	IC	<i>Ilex comuta 'Burfordii Nana'</i>	Dwarf Burford Holly	18" HT.	3 GAL.	
61	IV	<i>Ilex vomitoria 'Nana'</i>	Dwarf Yaupon Holly	18" HT.	3 GAL.	
4	OH	<i>Ilex x 'Conof'</i>	Oak Leaf Holly	5'-6" HT.	B&B	
27	IP	<i>Illicium parviflorum 'Florida Sunshine'</i>	Florida Sunshine Anise Tree	18" HT.	3 GAL.	
34	LC	<i>Loropetalum chinense 'Crimson Fire'</i>	Crimson Fire Fringeflower	18" HT.	3 GAL.	
4	MC	<i>Myrica cerifera</i>	Wax Myrtle	24" HT.	5 GAL.	
56	PA	<i>Pennisetum alopecuroides 'Hamel'</i>	Hamel Dwarf Fountain Grass	12" HT.	3 GAL.	
40	RH	<i>Rhaphiolepis indica</i>	Indian Hawthorn	24" HT.	3 GAL.	

TURF

8,000	LAWN	<i>Cynodon dactylon</i>	Hybrid Bermudagrass	SOD
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NOTES:
* PLANT HEIGHTS LISTED ARE THE MINIMUM HEIGHTS AT INSTALLATION.
** PLANT SIZES ARE THE MINIMUM CALIPER AT INSTALLATION FOR TREES. CONTAINER SIZE SHOWN FOR OTHER
** PLANT IS TO BE USED AS A GUIDE; PLANT HEIGHTS LISTED SHALL GOVERN.

THE LOCATION OF EXISTING UNDERGROUND UTILITIES ARE SHOWN IN AN APPROXIMATE MANNER ONLY AND ARE NOT BEING GUARANTEED BY THE OWNER OR HIS REPRESENTATIVE. THE CONTRACTOR SHALL DETERMINE THE EXACT LOCATION OF ALL EXISTING UTILITIES BEFORE COMMENCING WORK AND SHALL BE FULLY RESPONSIBLE FOR ANY AND ALL DAMAGES WHICH MAY BE OCCASIONED BY THE CONTRACTOR'S FAILURE TO EXACTLY LOCATE AND PRESERVE ANY AND ALL UNDERGROUND UTILITIES.

NOTICE:
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1191
W. WESTING
01.24.2020

C-482
WILMINGTON, N.C.
MEETING & CONSTRUCTION

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SEPI, INC.

TOTAL SITE COVERAGE

TOTAL SITE AREA	3.97 AC
TREES REQ. PER ACRE	15
TREES PROVIDED	60
TREES PRESERVED FOR THIS PROJECT	101
TOTAL 78.83 CREDITS	

PARKING LOT ISLAND TREES

INTERNAL PARKING ISLAND	DOUBLE ISLAND		TOTAL TREES
	AREA (SF)	TREES	
1	1,154	432	3
2	4,364	432	11
3	1,119	432	3
4	1,524	432	4
5	447	432	1
6	436	432	1
7	225	432	1
8	288	432	1
9	2,820	432	7
TOTALS	12,377	9	32

FOUNDATION PLANTINGS

	BUILDING FACE AREA (SF)	MULTIPLIER (%)	FOUNDATION PLANTINGS AREA (SF)
REQUIRED	12,140	12	1,459
PROVIDED			7,117

NOTE:
BUILDING FAÇADE AREA INCLUDES EAST, SOUTH, AND WEST FAÇADES. NORTH FAÇADE NOT INCLUDED DUE TO DRIVE THRU.

STREET YARD CALCULATIONS

STREET YARD	LENGTH (FT)	MULTIPLIER	REQUIRED AREA (SF)
NORTH (HOLLINGSWORTH DR)	± 606	9	5,454
1 TREE PER 600 SF = 10 TREES REQUIRED, 10 TREES PROVIDED (7 EXISTING + 3 PROPOSED)			
6 SHRUBS PER 600 SF = 55 SHRUBS REQUIRED, 55 SHRUBS PROVIDED			
TOTAL STREET YARD AREA 14,895 SF			
IMPERVIOUS AREA 271 SF (1.82%)			
EAST (PEEL ST.)	± 234	9	2,106
1 TREE PER 600 SF = 4 TREES REQUIRED, 4 TREES PROVIDED (4 EXISTING + 0 PROPOSED)			
6 SHRUBS PER 600 SF = 22 SHRUBS REQUIRED, 22 SHRUBS PROVIDED			
TOTAL STREET YARD AREA 6,025 SF			
IMPERVIOUS AREA 135 SF (2.24%)			
SOUTH (17th STREET)	± 504	18	9,072
1 TREE PER 600 SF = 16 TREES REQUIRED, 16 TREES PROVIDED (5 EXISTING + 11 PROPOSED)			
6 SHRUBS PER 600 SF = 91 SHRUBS REQUIRED, 91 SHRUBS PROVIDED			
TOTAL STREET YARD AREA 12,443 SF			
IMPERVIOUS AREA 22 SF (0.18%)			
WEST BOUNDARY	± 350	9	3,141
1 TREE PER 600 SF = 6 TREES REQUIRED, 6 TREES PROVIDED (10 EXISTING + 6 PROPOSED)			
6 SHRUBS PER 600 SF = 32 SHRUBS REQUIRED, 32 SHRUBS PROVIDED			
TOTAL STREET YARD AREA 2,930 SF			
IMPERVIOUS AREA 101 SF (3.45%)			

REMOVED TREES


	CREDIT	%	CREDIT	REPLACEMENT TREES
22" PINE	4	100%	4	(4) 2" BALD CYPRESS

PARKING LOT AREA

	AREA (SF)	
SURFACE AREA	57,390	SF
20% TREE COVERAGE REQ'D	11,478	SF
COVERAGE PER INTERIOR TREE	707	SF
TREES REQUIRED	17	
TREES PROVIDED	17	

Approved Construction Plan
Name: Nicole Smith, Date: 1/31/20
Planning Traffic Fire: W. Minton, Ch. G... 1-31-20 2/4/20

CITY OF WILMINGTON
Public Services • Engineering Division
APPROVED STORMWATER MANAGEMENT PLAN
Date: 1/30/2020 Permit #: 2020003
Signed: [Signature]

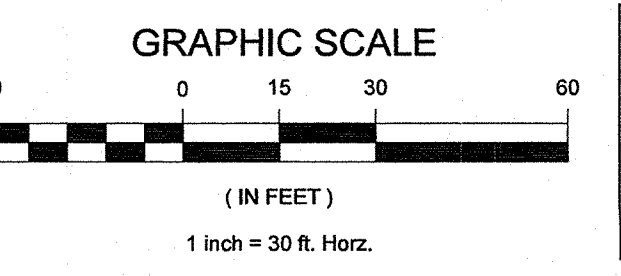

For each open utility cut of City streets, a \$325 permit shall be required from the City prior to occupancy and/or project acceptance.


OWNER/DEVELOPER/APPLICANT
STATE EMPLOYEES' CREDIT UNION
ADDRESS: 110 N. SALISBURY STREET, RALEIGH, NORTH CAROLINA 27603, PHONE: 919-899-5500

PROJECT
STATE EMPLOYEES' CREDIT UNION - WILMINGTON
517th STREET BRANCH
ADDRESS: 4355 S 17TH STREET, WILMINGTON, NC 28412

PROJECT MANAGER: MTA
CHECKED BY: DM
DRAWN BY: KD


FIELD SURVEY DATE: 02/15/19
DRAWING DATE: 12/03/2019
JOB #: SE1819100

LANDSCAPE PLAN
SHEET
L-10

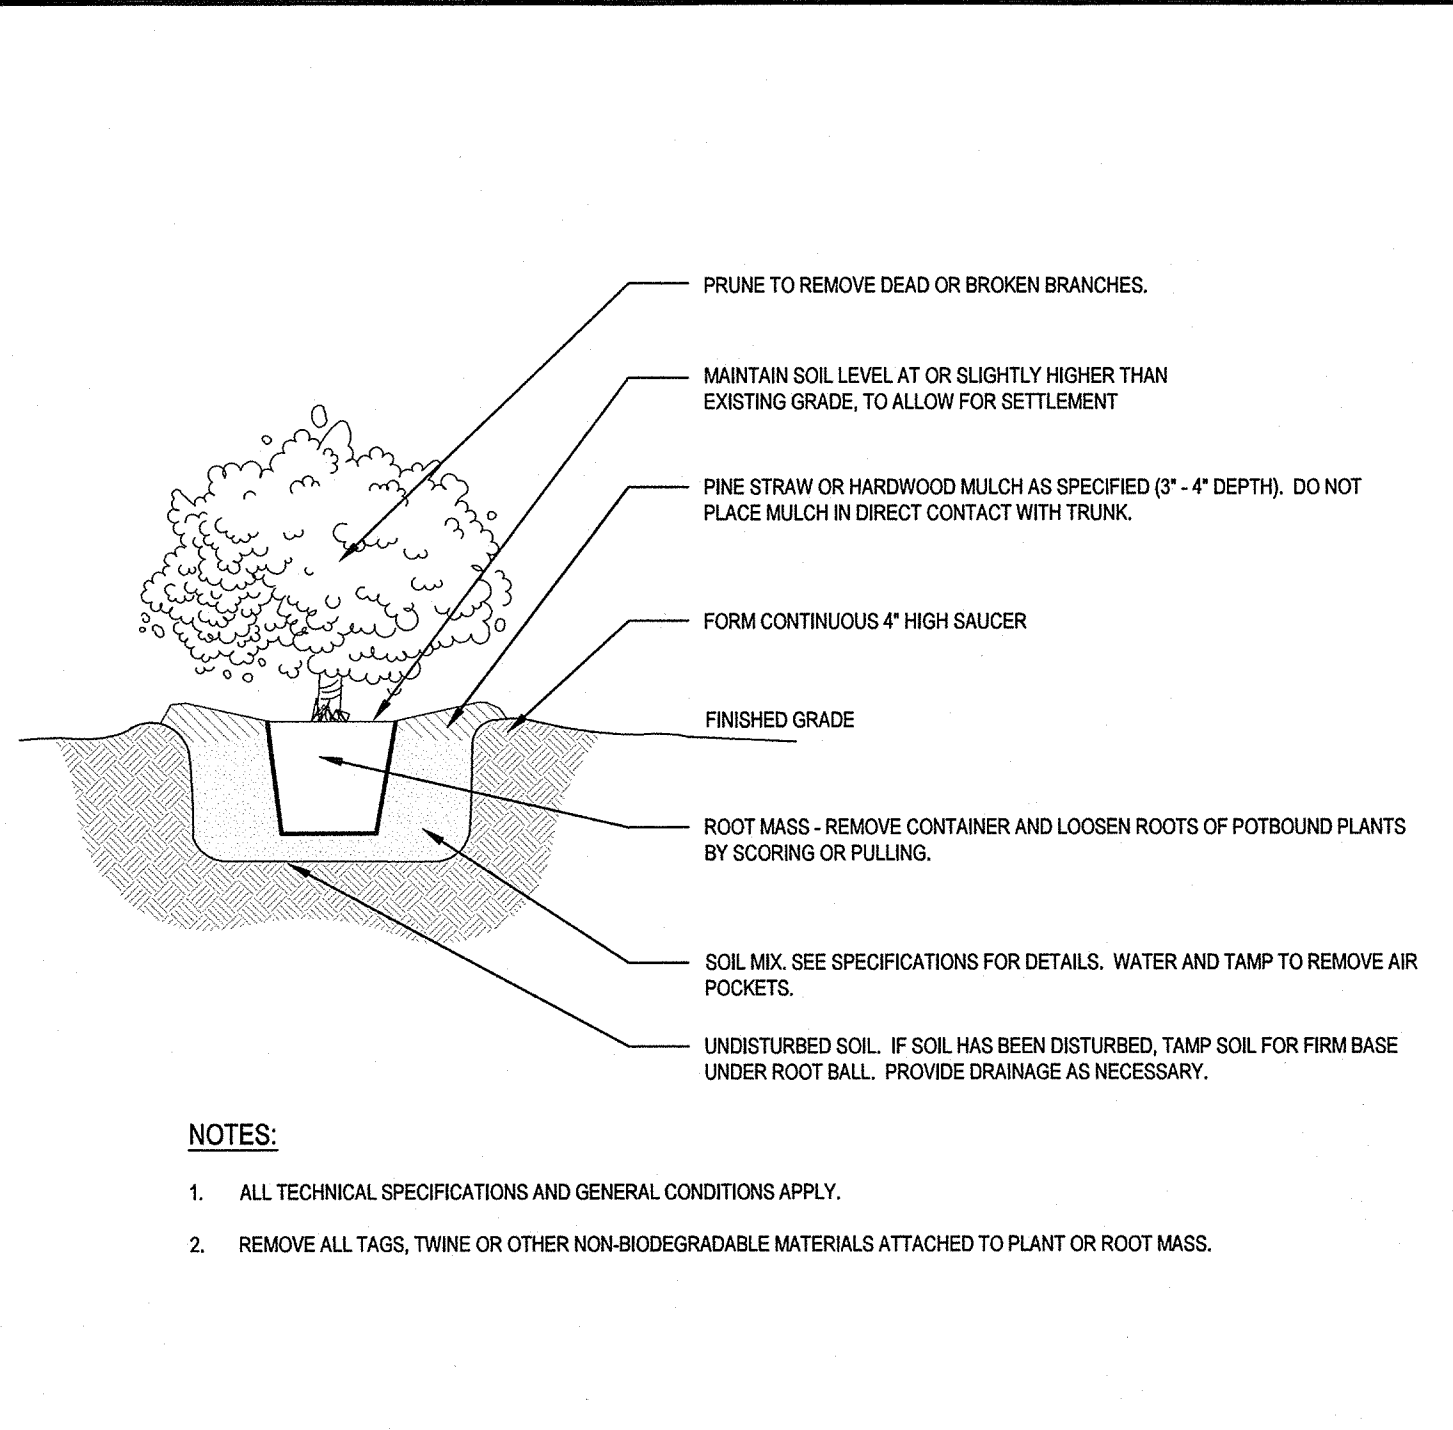


- NOTES:**
- ALL TECHNICAL SPECIFICATIONS AND GENERAL CONDITIONS APPLY.
 - REMOVE ALL TAGS, TWINE OR OTHER NON-BIODEGRADABLE MATERIALS ATTACHED TO PLANT OR ROOT MASS.

SHRUB & ORNAMENTAL GRASSES PLANTING
SCALE: NTS 3

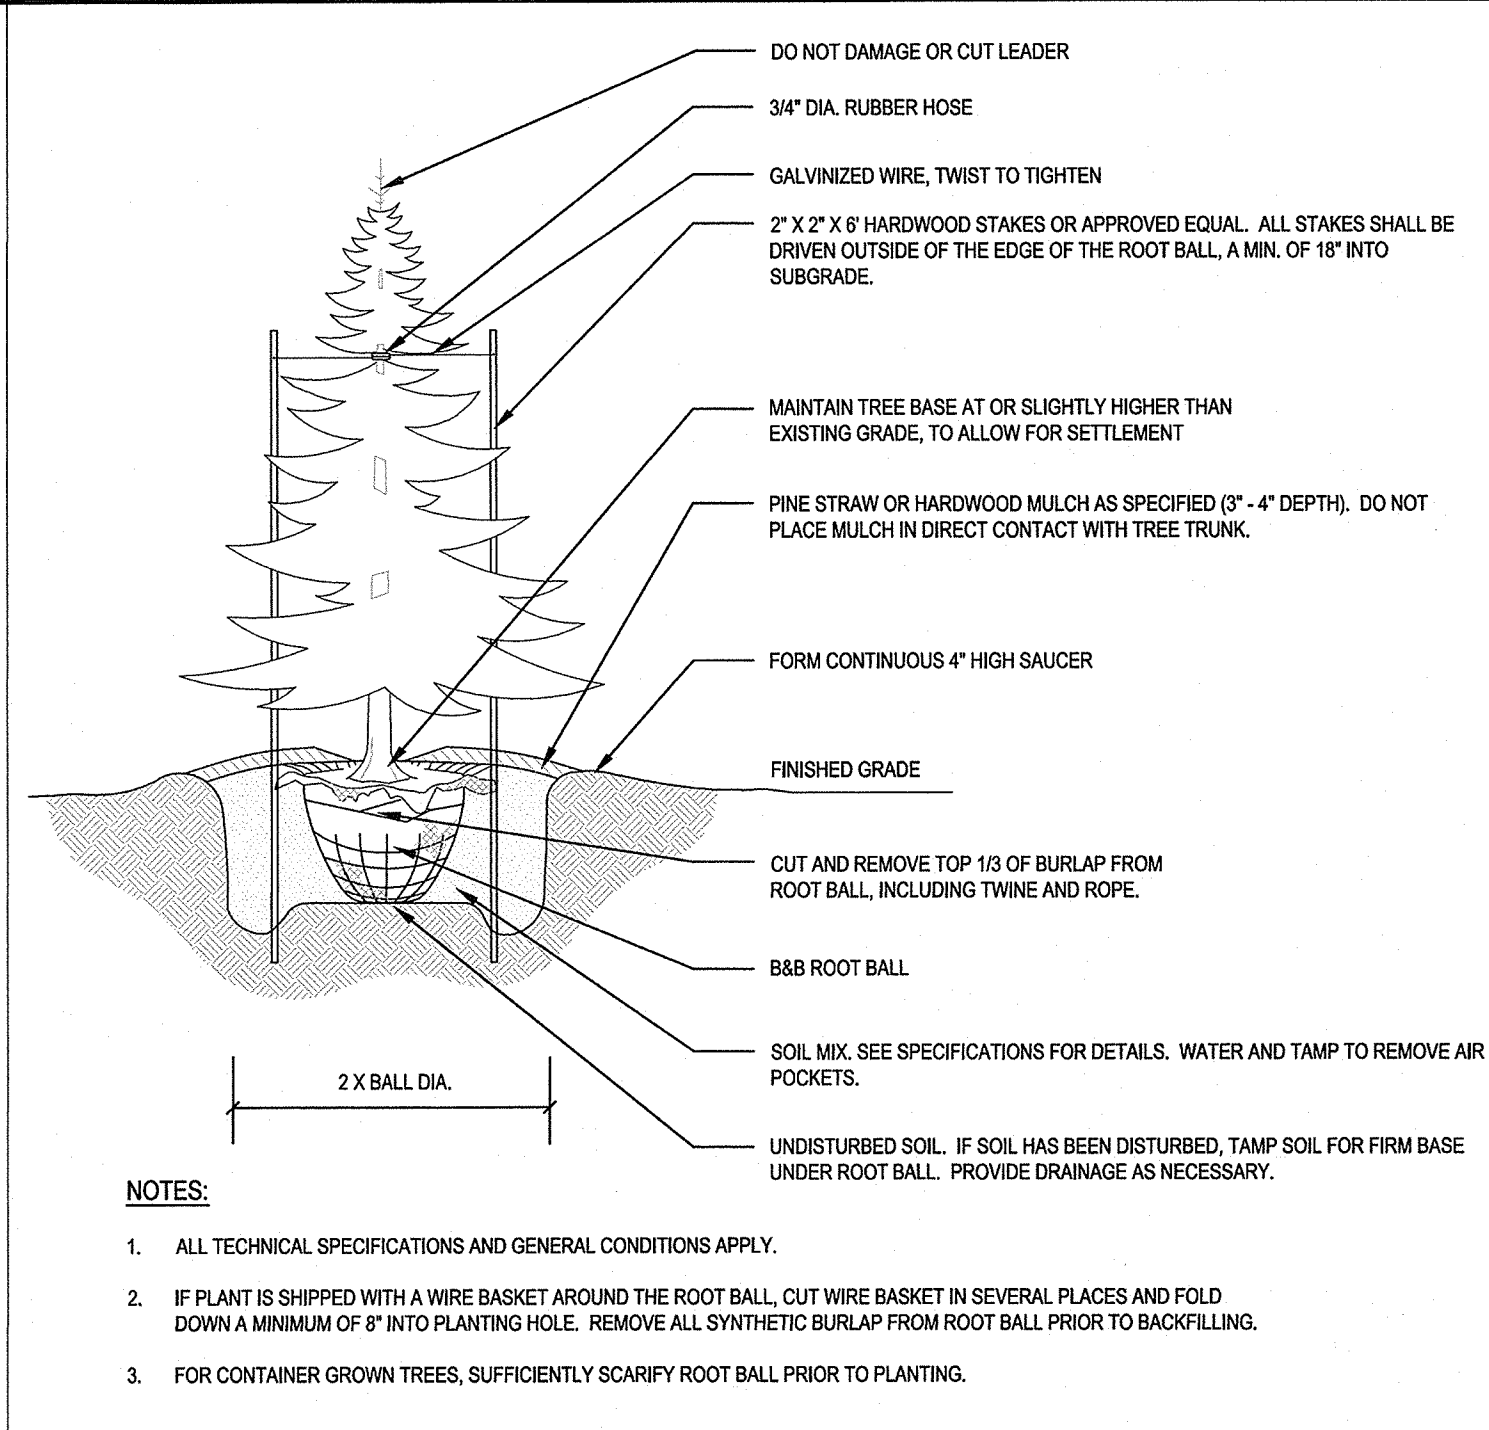

- NOTES:**
- ALL TECHNICAL SPECIFICATIONS AND GENERAL CONDITIONS APPLY.
 - IF PLANT IS SHIPPED WITH A WIRE BASKET AROUND THE ROOT BALL, CUT WIRE BASKET IN SEVERAL PLACES AND FOLD DOWN A MINIMUM OF 8\"/>
 - FOR CONTAINER GROWN TREES, SUFFICIENTLY SCARIFY ROOT BALL PRIOR TO PLANTING.

CONIFER TREE PLANTING
SCALE: NTS 2

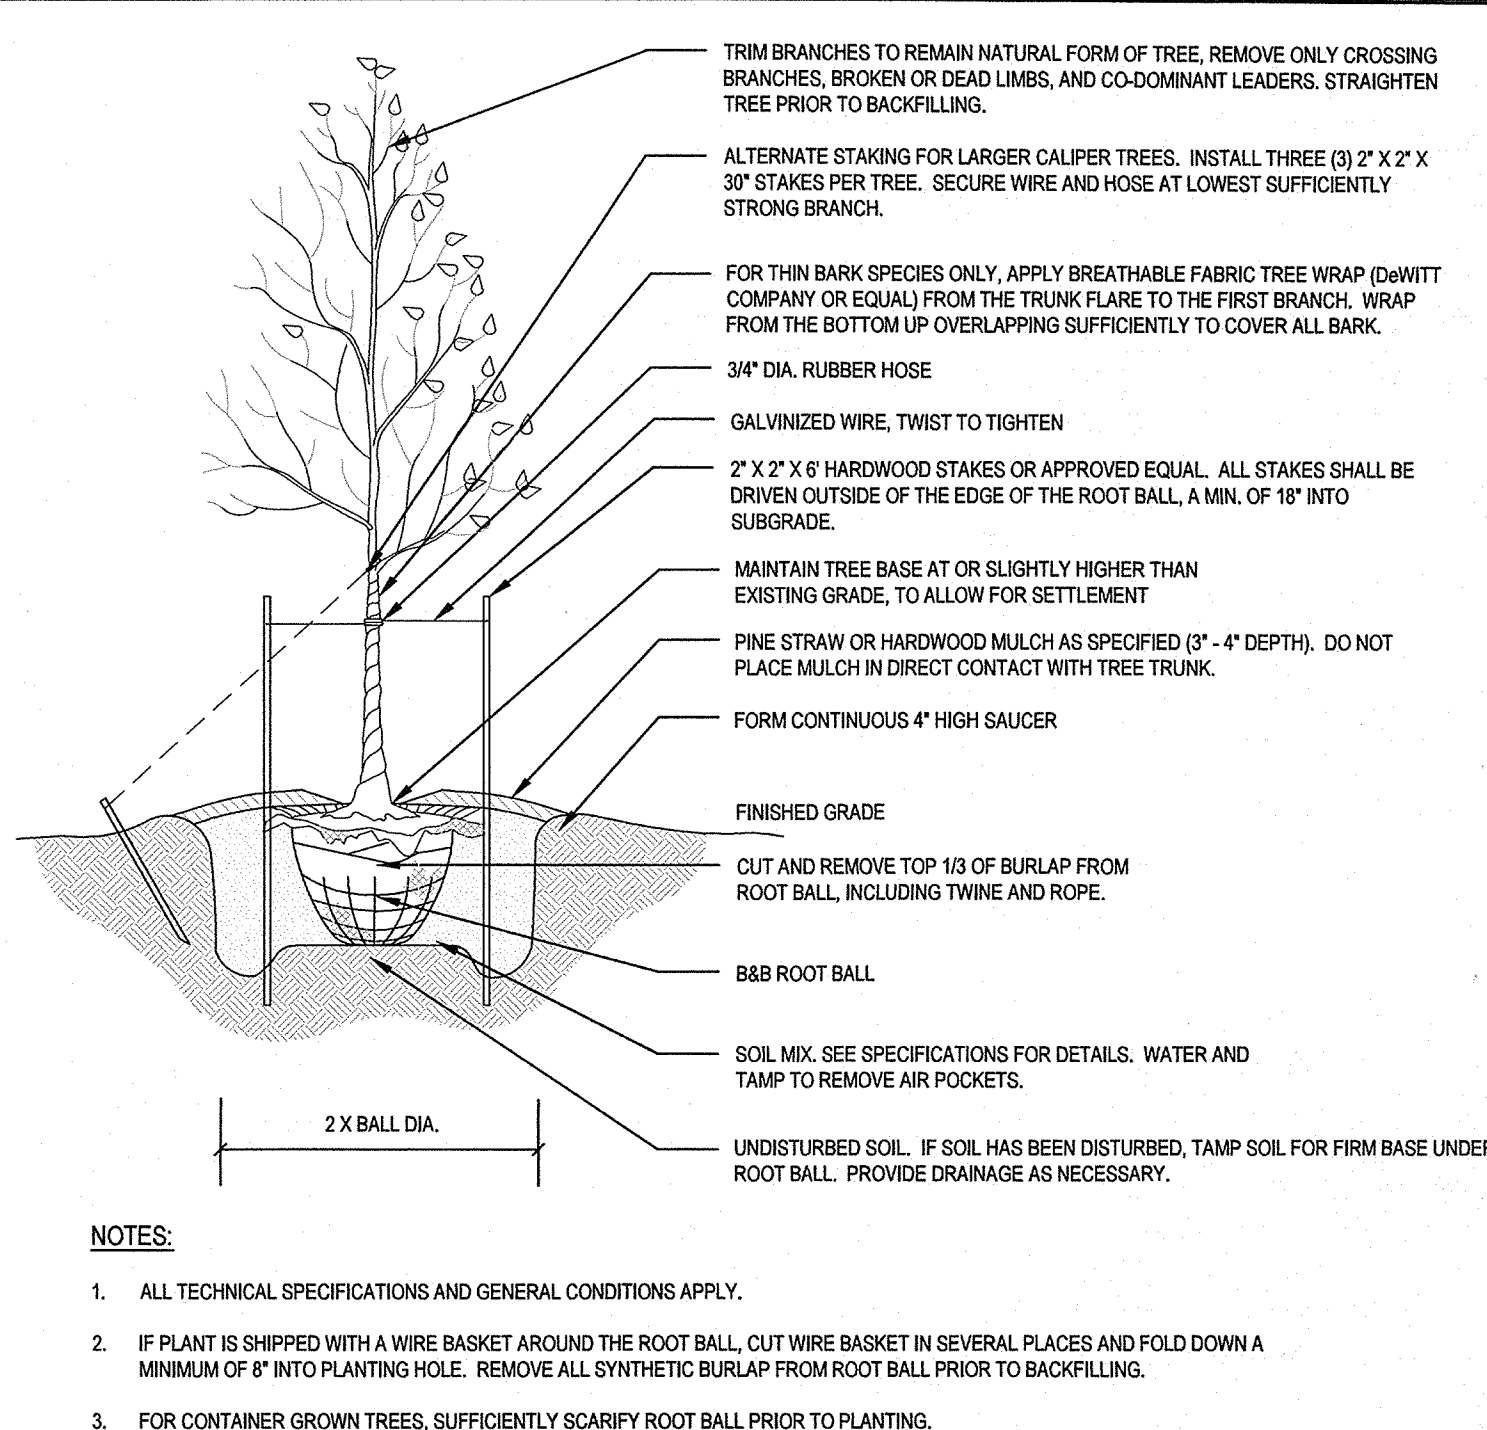

- NOTES:**
- ALL TECHNICAL SPECIFICATIONS AND GENERAL CONDITIONS APPLY.
 - IF PLANT IS SHIPPED WITH A WIRE BASKET AROUND THE ROOT BALL, CUT WIRE BASKET IN SEVERAL PLACES AND FOLD DOWN A MINIMUM OF 8\"/>
 - FOR CONTAINER GROWN TREES, SUFFICIENTLY SCARIFY ROOT BALL PRIOR TO PLANTING.



DECIDUOUS TREE PLANTING
SCALE: NTS 1

SEPI
1 GLENWOOD AVE., SUITE 600
RALEIGH, NC 27603
PHONE 919.789.9977
11202 DAVID TAYLOR DR., SUITE 115
CHARLOTTE, NC 28282
PHONE 704.714.4880
5030 NEW CENTRE DR., SUITE B
WILMINGTON, NC 28403
PHONE 910.523.5715
sepiinc.com

811
Know what's below.
Call before you dig.
3 WORKING DAYS
BEFORE YOU DIG
FOR THE LOCATION OF
UNDERGROUND FACILITIES

THE LOCATION OF EXISTING UNDERGROUND UTILITIES ARE SHOWN IN AN APPROXIMATE MANNER ONLY AND HAVE NOT BEEN RECENTLY VERIFIED BY THE OWNER OR ITS AGENTS OR ADVISORS. THE CONTRACTOR SHALL DETERMINE THE EXACT LOCATION OF ALL EXISTING UTILITIES BEFORE COMMENCING WORK, AND ASSUMES TO BE FULLY RESPONSIBLE FOR ANY AND ALL DAMAGES WHICH MAY BE OCCURRED BY THE CONTRACTOR'S FAILURE TO EXACTLY LOCATE AND PRESERVE ANY AND ALL UNDERGROUND UTILITIES.

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ADDRESS:
119 N. SALISBURY STREET
RALEIGH, NORTH CAROLINA 27603
PHONE: 919-859-5900

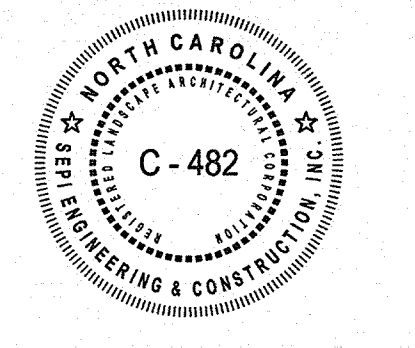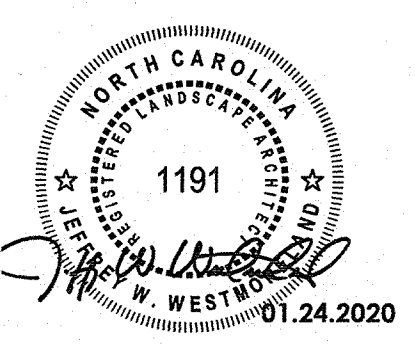PROJECT
STATE EMPLOYEES' CREDIT UNION - WILMINGTON 5 17th STREET BRANCH
ADDRESS:
4355 S 17TH STREET
WILMINGTON, NC 28412

PROJECT MANAGER
MTA
CHECKED BY:
DM
DRAWN BY:
KD
FIELD SURVEY DATE:
02/15/19
DRAWING DATE:
12/03/2019
JOB #:
SEI1819100
SHEET
L-2.0

Approved Construction Plan

Name	Date
Planning: Nicole Demuth	11/31/20
Traffic: W. Edwards	1-31-20
Fire: Chisholm	2/4/20

CITY OF WILMINGTON NORTH CAROLINA
Public Services • Engineering Division
APPROVED STORMWATER MANAGEMENT PLAN
Date: 1/30/2020 permit # 2020003
Signed: Rich Christman

For each open utility cut of City streets, a \$325 permit shall be required from the City prior to occupancy and/or project acceptance